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RELATED APPLICATIONS:

122887224 – NB 122887224 – FENCE 122887224 – STRUCTURAL

122887224 - SOE

122887224 - FOUNDATION

SIDEWALK SHED TO BE FILED

122887224 - PLUMBING

BLOCK: 1158 LOT: 133 BIN: 1030358 **CB**: 107 CONSTRUCTION CLASSIFICATION: I-A: 3 HOUR PROTECTED - NON COMBUST OCCUPANCY CLASSIFICATION: R-2- RESIDENTIAL:APARTMENT HOUSES PROPOSED HEIGHT: ZONING DIST: R8-GENERAL RESIDENCE DISTRICT MAP NO . JOB APPLICATION NO.: 122887224 - NB BOX 9c CHECKED: YES B.I.S. REQUIRED INFO ENTERED: YES

SITE SAFETY PLAN FOR A 51 STORY NEW BUILDING AT 200 AMSTERDAM AVE NEW YORK, NY 10024



EMAJOR BUILDING CONSULTING CONSTRUCTION CODE & SAFETY EXPERTS

21 W 38TH STREET, 11TH FLOOR NEW YORK, NY 10018 PH: 646-626-7373 ATTN: SANDEEP GUNNALA.

DRAWING LIST TITLE SHEET SSP-001.01 X X SSP-002.00 GENERALMOTES TYPICAL EXCAVATION PLAN X SSP-100.01 X SSP-110.01 X TYPICAL FOUNDATION PLAN CELLAR LVL 3 X SSP-120.01 TYPICAL FOUNDATION PLAN CELLAR LVL 2 X X SSP-130.01 TYPICAL FOUNDATION PLAN CELLAR LVL 1 X

			SSP-900.00 TYPICAL DETAILS	
B.E.S.T:	B.E.S.T SQUAD 2 LAFAYETTE STREET, 12TH FLOOR NEW YORK, NY 10007 (212) 602-0406		AMBULANCE:	ST. LUKE'S ROOSEVELT HOSPITAL CENTER 1000 TENTH AVENUE NEW YORK, NY 10019 212-523-4000
D.O.B.:	MANHATTAN BOROUGH OFFICE 280 BROADWAY MANHATTAN, NY 10007 (212) 393–2614	EMERGENCY	FIRE HOUSE:	ENGINE 40 LADDER 35 131 AMSTERDAM AVENUE NEW YORK, NY 212-570-4240
GENERAL INFORMATION AND COMPLAINTS:	311	TELEPHONE	D.O.T.:	BUREAU OF PERMIT MANAGEMENT AND CONSTRUCTION CONTROL (OCMC) 55 WATER STREET
MAJOR BUILDING CONSULTING	MAJOR BUILDING CONSULTING 21 WEST 38TH ST, 12TH FL NEW YORK, NY 10018 P: (212) 683-7200			NEW YORK, NY 10041 (212) 839-9588
			POLICE PRECINCT HOUSE:	20TH PRECINCT 120 W 82ND ST
D.O.B. INCIDENTS REPORTING	212-393-2128			NEW YORK, NY 10024 212-580-6411

Site Safety Plan for: 200 AMSTERDAM AVE NEW YORK, NY

Owner

AMSTERDAM AVE REDEVELOPMENT A 11 TIMES SQUARE NEW YORK, NY 10036 PH:201-592-1311 ATTN:VICTOR CIVIDINI

Safety Engineer/Designer

Major Building Consulting 21 W 38th Street, 11th Floor New York, NY 10018 Ph: 646-626-7373 Attn: Sandeep Gunnala.

Architect/Engineer


ELKUS / MANFREDI ĀRCHITECTS 25 DRYDOCK AVENUE BOSTON, MA 02210 Ph: 617-426-1300 Attn: HOWARD F ELKUS LICENCE: 018768

Contractor Pavarini McGovern LLC

770 Broadway New York, NY 10003 Ph: 212-907-0900 Attn: Eric McGovern Proj Super: A.B. Olevic - Lic 1660

Site Safety Manager

Major Building Consulting 21 W 38th Street, 11th Floor New York, NY 10018 Ph: 646-626-7373 SSM TO BE DETERMINED

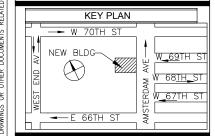

REPARED BY:


BUILDING CONSULTING
CONSTRUCTION CODE & SAFETY EXPERTS
21 WEST 38TH ST, 11TH FL
NEW YORK, NY 10018
TEL: 646-626-7373

PRDJECT: New Building At 51 Stories
200 AMSTERDAM AVE
New York, NY 10024, 642' HT
Block 1158, Lot 133, CB 107
Job # 122887224, BIN: 1030358

DRAWING TITLE:
TITLE SHEET



SCALE:	DWG NO.:
N/A	SSP-001.01
DATE: 11-06-17	FILE NUMBER: 1
DRAWN BY: N.H .	200 AMSTERDAM
CHECK BY: S.G.	AV /

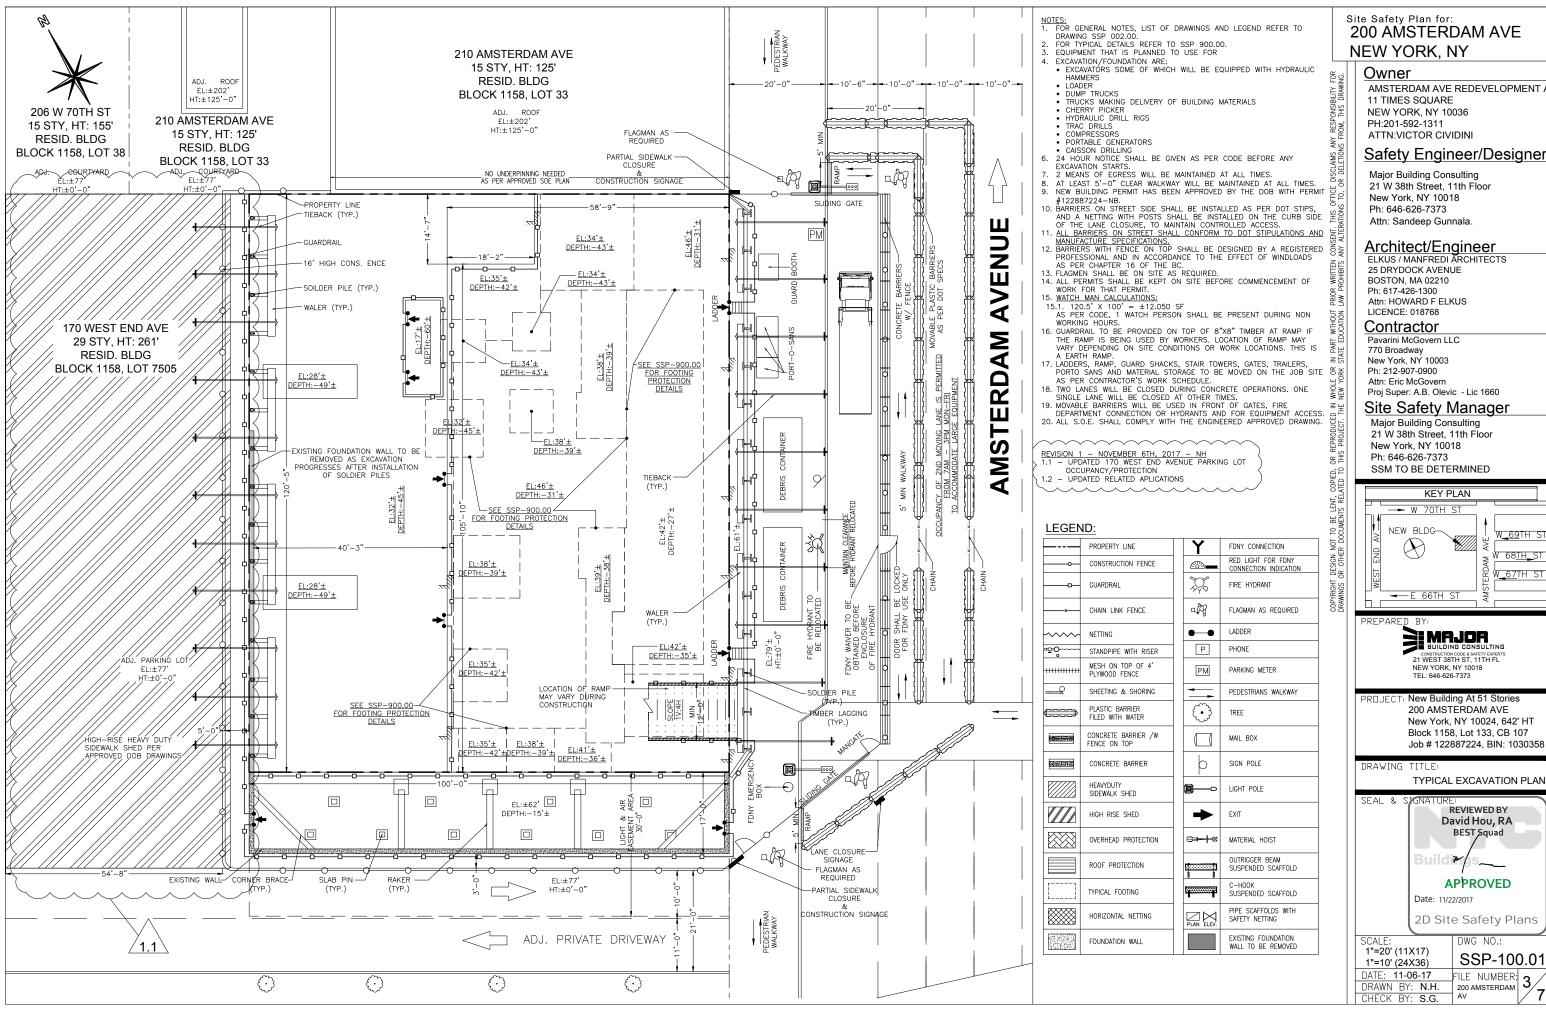

200 AMSTERDAM AVE


AMSTERDAM AVE REDEVELOPMENT A

Safety Engineer/Designer

W<u>_69</u>TH : W 68TH_S1 W<u>_67</u>TH ST



LE:	DWG NO.:
=20' (11X17)	SSP-100.0
=10' (24X36)	001
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Safety Engineer/Designer

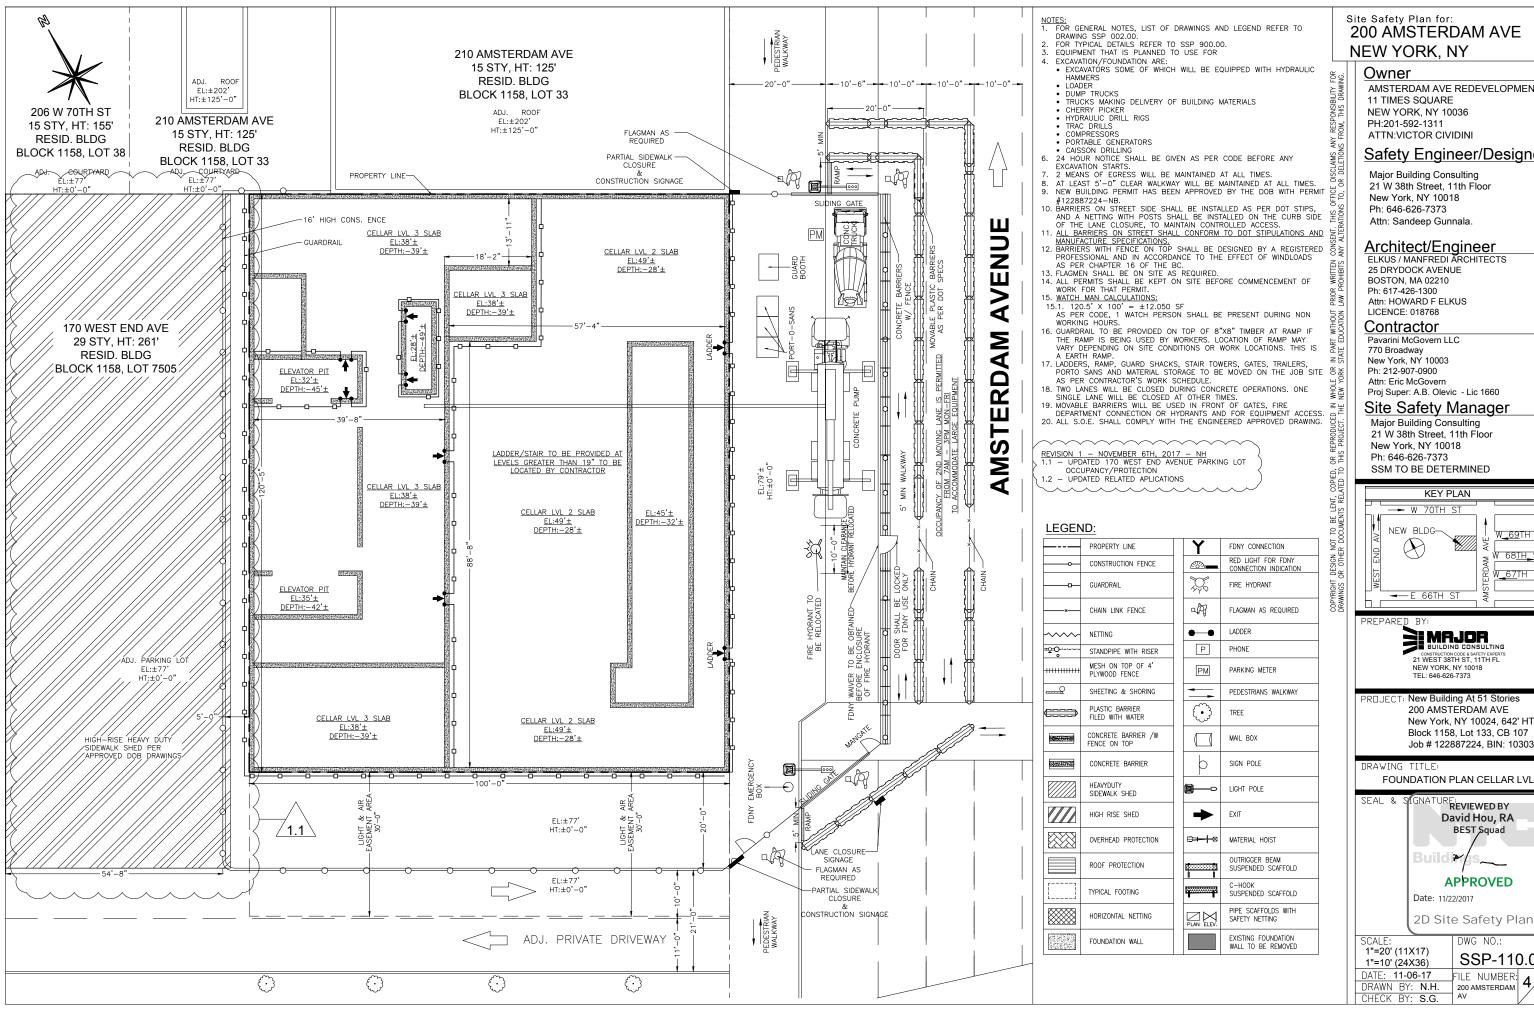
W 68TH_S W<u>_67</u>TH ST

New York, NY 10024, 642' HT Block 1158, Lot 133, CB 107 Job # 122887224, BIN: 1030358

FOUNDATION PLAN CELLAR LVL 3



CALF:	DWG NO.:
"=20' (11X17) "=10' (24X36)	SSP-110.0
TE: 11-06-17	FILE NUMBER: 1

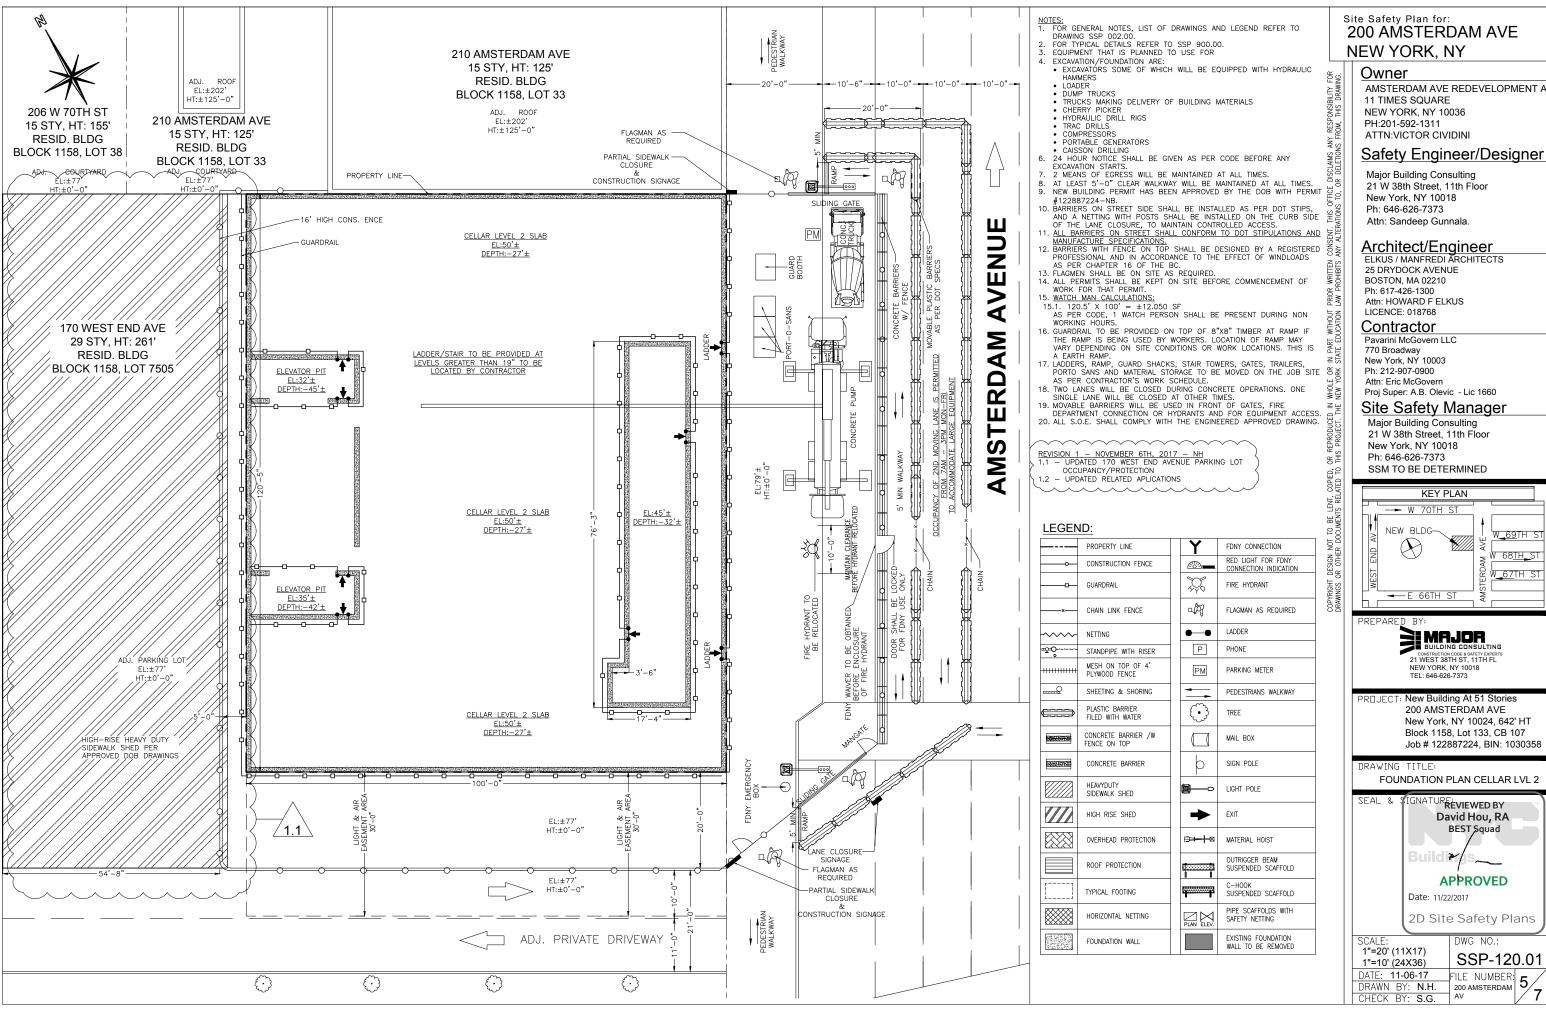




New York, NY 10024, 642' HT



SSP-120.01

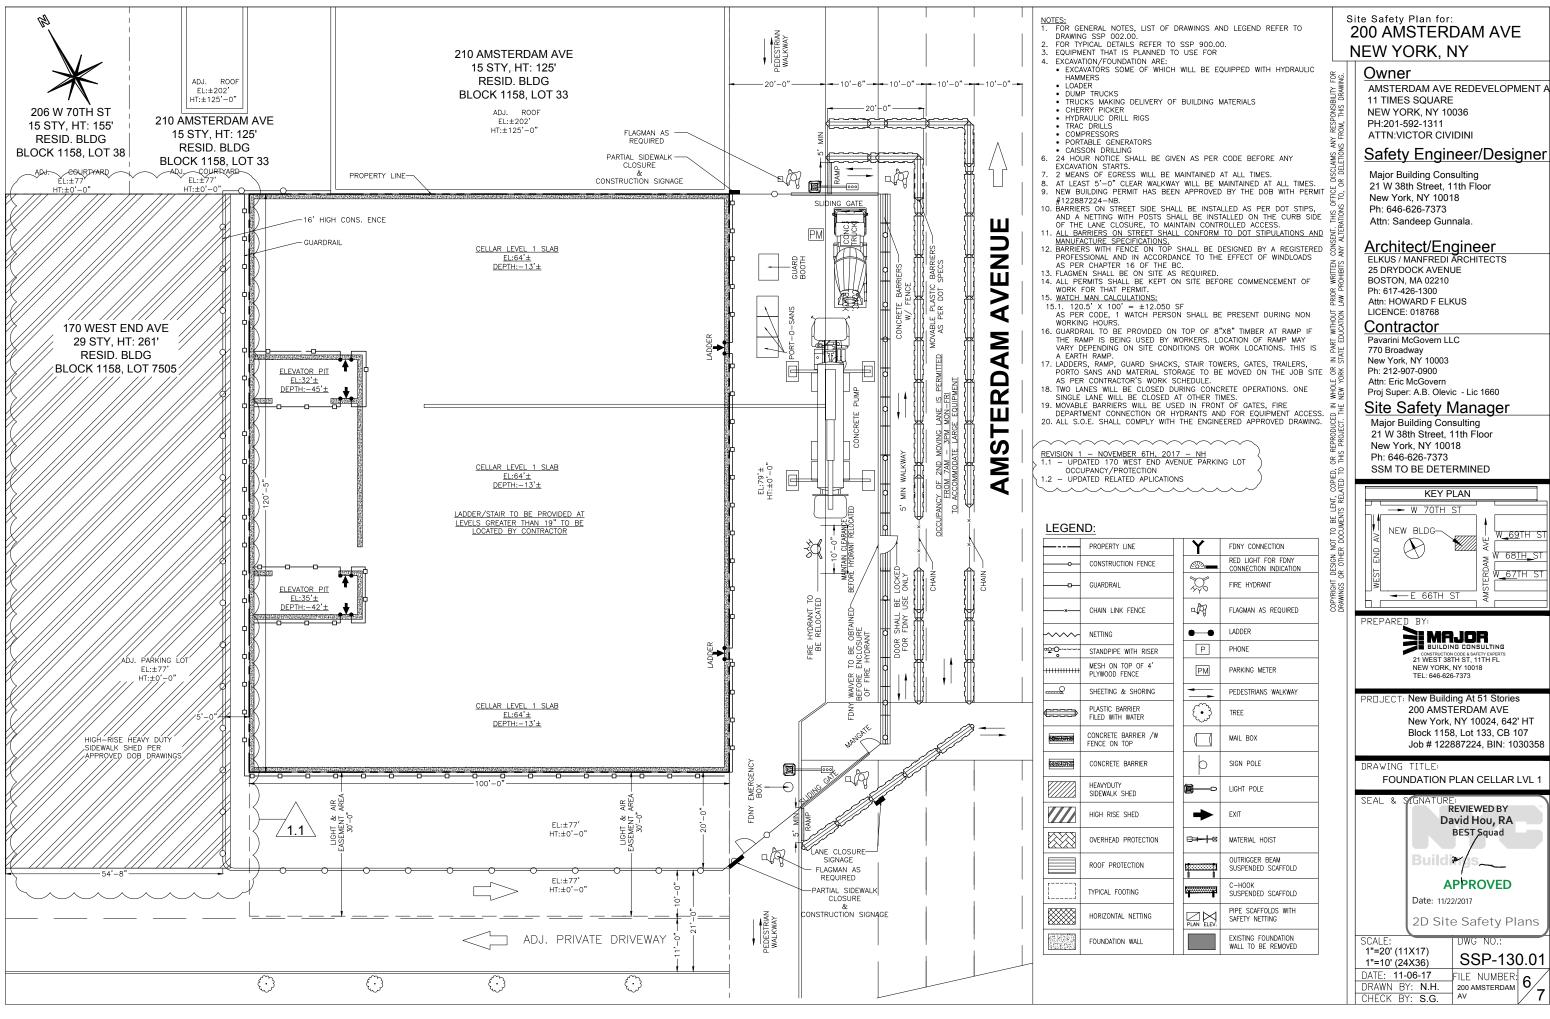





SSP-130.01



BLOCK: 1158	LOT: 133	BIN: 1030358	CB : 107		
CONSTRUCTION CLASSIFICATION:		I-A: 3 HOUR PROTECTED	I-A: 3 HOUR PROTECTED - NON COMBUST		
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PROPOSED HEIGHT	Γ:	±642			
ZONING DIST:		R8-GENERAL RESIDENCE DISTRICT			
MAP NO.:		8c	8c		
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BOX 9c CHECKED:		YES		E S	
B.I.S. REQUIRED INFO ENTERED:		YES			
				S × l	

SITE SAFETY PLAN FOR A 51 STORY NEW BUILDING AT 200 AMSTERDAM AVE NEW YORK, NY 10024

Work shall not be started until permitted

Granted Partial Approval for excavation & Foundation only

PREPARED BY,



21 W 38TH STREET, 11TH FLOOR NEW YORK, NY 10018 PH: 646-626-7373 ATTN: SANDEEP GUNNALA.

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	DRAWING LIST	/5	MILE		
SSP-001.00	TITLE SHEET	X			
SSP-002.00	GENERAL NOTES	X			
SSP-100.00	TYPICAL EXCAVATION PLAN	X			
SSP-110.00	TYPICAL FOUNDATION PLAN CELLAR LVL 3	X			
SSP-120.00	TYPICAL FOUNDATION PLAN CELLAR LVL 2	X			
SSP-130.00	TYPICAL FOUNDATION PLAN CELLAR LVL 1	X			
SSP-900.00	TYPICAL DETAILS	X			

B.E.S.T:	B.E.S.T SQUAD 280 BROADWAY, 5TH FLOOR NEW YORK, NY 10007 (212) 393-2404		AMBULANCE:	ST. LUKE'S ROOSEVELT HOSPITAL CENTER 1000 TENTH AVENUE NEW YORK, NY 10019 212-523-4000
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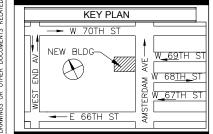
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PREPARED BY:

BUILDING CONSULTING
CONSTRUCTION CODE & SAFETY EXPERTS
21 WEST 38TH ST, 11TH FL
NEW YORK, NY 10018
TEL: 646-626-7373

PROJECT: New Building At 51 Stories
200 AMSTERDAM AVE

200 AMSTERDAM AVE New York, NY 10024, 642' HT Block 1158, Lot 133, CB 107 Job # 122887224, BIN: 1030358

DRAWING TITLE:
TITLE SHEET

SEAL & SIGNATURE:



SCALE:	DWG NO.:
N/A	SSP-001.00
DATE: 12-27-16	FILE NUMBER: 1 /
DRAWN BY: F.K.	200 AMSTERDAM
CHECK BY: S.G.	AV /

RELATED APPLICATIONS:

1.0 CONTRACTOR'S RESPONSIBILITY

- WORK MUST CONFIRM TO ALL THE REQUIREMENTS OF 2014 NEW YORK CITY BUILDING CODE, FIRE DEPARTMENT REGULATIONS AND ALL APPLICABLE LAWS. THE WORK WILL CONFIRM TO LITILITY COMPANY REQUIREMENTS AND THE BEST TRADE PRACTICES AS WELL AS THE PROJECT SAFETY PLAN AND CONTRACT DOCUMENTS
- BEFORE COMMENCING WORK, THE CONTRACTOR SHALL FILE ALL REQUIRED INSURANCES WITH THE DEPARTMENT OF BUILDINGS, OBTAIN ALL PERMITS FROM ALL APPLICABLE NEW YORK CITY AGENCIES AND APPLY THE FEES REQUIRED BY NEW YORK CITY AGENCIES.
- THE CONTRACTORS SHALL VERIFY ALL EXISTING CONDITIONS IN THE FIELD PRIOR TO COMMENCING WORK. CONTRACTOR SHALL REPORT ALL DISCREPANCIES BETWEEN DRAWINGS AND FIELD CONDITIONS TO THE PROFESSIONAL ENGINEER OR THE REGISTERED ARCHITECT.
- PLUMBING AND ELECTRICAL WORK IF ANY SHALL BE PERFORMED BY PERSONS LICENSED IN THEIR TRADES, WHO SHALL ARRANGE INSPECTIONS AND OBTAIN REQUIRED SIGN-OFFS
- AT LEAST (24) TWENTY-FOUR HOUR WRITTEN NOTICE SHALL BE GIVEN TO THE DEPARTMENT OF BUILDINGS BEFORE THE COMMENCEMENT OF ANY WORK FOR WHICH A PERMIT HAS BEEN OBTAINED. BEFORE ANY WORK IS COMMENCED ON AN ITEM OF CONSTRUCTION REQUIRED CONTROLLED INSPECTIONS SHALL BE NOTIFIED IN WRITING AT LEAST 72 (SEVENTY-TWO) HOURS PRIOR TO SUCH COMMENCEMENT AS PER SECTION 3304.3 OF THE NEW YORK CITY BUILDING CODE.
- A LICENSE TO ENTER THE ADJOINING PREMISES SHALL BE OBTAINED.WHEN PERMISSION TO ENTER THE ADJOINING PROPERTY HAS BEEN OBTAINED, A PHYSICAL EXAMINATION OF THE PROPERTY SHALL BE CONDUCTED BY THE PERSON INITIATING THE CONSTRUCTION OR PERFORMING DEMOLITION OPERATIONS PRIOR TO COMMENCEMENT OF WORK.
- ITS THE CONTRACTOR'S RESPONSIBILITY TO HAVE THEIR WORKERS A 10 HOUR OSHA TRAINING CARD AND OTHER REQUIRED TRAINING CARDS FROM DOB TO PERFORM WORK.

2.0 SIDEWALK SHED SAFETY NOTES

- SIDEWALKS, WALKWAYS AND SIDEWALK WITH SHED SHOULD BE CLOSED FOR PUBLIC DURING HOISTING OPERATIONS; IF THE HOISTING IS DONE ABOVE. PERMITS FOR SIDEWALK SHEDS SHALL BE OBTAINED AS REQUIRED IN
- SECTION 3303.6 OF THE NEW YORK BUILDING CODE
- SIDEWALK SHEDS SHALL BE DESIGNED BY A LICENSED PROFESSIONAL AS REQUIRED IN SECTION 3307.6.3. DRAWINGS SHALL BE SUBMITTED FOR APPROVAL TO CONSTRUCTION MANAGER PRIOR TO COMMENCING ERECTION SIDEWALK SHEDS SHALL BE ERECTED AS SHOWN ON THE APPROVED PLANS
- AND REMAIN IN PLACE UNTIL ALL EXTERIOR WORK IS COMPLETED. THIS INCLUDES REMOVAL OF ALL HOISTING FOUIPMENT, DERRICKS, CRANES, SUSPENDED SCAFFOLDS AND ALL EXTERIOR WORK ABOVE THE (2ND) SECOND FLOOR IS COMPLETED.
- SIDEWALK SHEDS ARE REQUIRED TO EXTEND (20'-0") TWENTY FEET BEYOND THE SIDE LOT LINES WHEN THE BUILDING EXCEEDS (100'-0") ONE HUNDRED FEET IN HEIGHT, AND (5'-0") FIVE FEET IF THE HEIGHT OF THE BUILDING IS LESS THAN (100'-0") HUNDRED FEET - FOR ATTACHED
- ALL ASPECTS OF SECTION 3319 OF THE NEW YORK CITY BUILDING CODE FOR ON SITE INSPECTION OF CRANES, DERRICKS AND CABLE WAYS SHALL RE MET
- ALL PIPING AND HANGING SCAFFOLDING IS TO BE ENCLOSED WITH VERTICAL SAFETY NETTING AS REQUIRED UNDER SECTION 3308 OF THE NEW YORK CITY BUILDING CODE.
- DURING ALL LIFTING AND HOIST OPERATIONS, FLAGMAN WILL BE PROVIDED TO CONTROL ALL PEDESTRIAN TRAFFIC. FLAGMAN WILL ALSO BE PROVIDED FOR ANY OTHER OPERATIONS AS BEING REQUIRED BY ALL CITY AGENCIES.
- PROVISIONS FOR INSPECTIONS TO ENSURE COMPLIANCE WITH BUILDING CODE SITE SAFETY REQUIREMENTS WILL BE COORDINATED AND THE TRADE CONTRACTOR SHALL DESIGNATE A SAFETY REPRESENTATIVE, WHO WILL BE RESPONSIBLE FOR DAILY INSPECTIONS, TOOL BOX TRAINING AND WILL HAVE NO OTHER DUTIES OTHER THAN KEEPING A DAILY LOG, TO BE AVAILABLE FOR INSPECTION.
- 2.10 MAN LIFT SHALL ACT AS AN EMERGENCY ELEVATOR FOR THE NYC FIRE DEPARTMENT AS REQUIRED IN SECTION 3310.12 OF THE NYC BUILDING
- 2.11 OBTAIN REQUIRED PERMITS FROM THE NEW YORK CITY DEPARTMENT OF TRANSPORTATION FOR ANY STREET OBSTRUCTION OR STREET CLOSING.
- 2.12 THE CONTRACTOR MUST STRICTLY COMPLY TO ANY OF THE FORGOING PROVISIONS INDICATED WITH IN CHAPTER 33 OF THE NEW YORK CITY BUILDING MANUAL.

3.0 NOISE AFTER HOURS

- CONTRACTORS SHALL OBTAIN AFTER HOURS WORK PERMITS FROM ALL APPLICABLE CITY AGENCIES IF WORKING AFTER HOURS.
- ALL WORKS TO BE DONE IN ACCORDANCE WITH CHAPTER 33 OF THE NEW YORK CITY BUILDING CODE AND REGULATIONS OF ALL THE OTHER CITY AGENCIES HAVING JURISDICTION.

4.0 STRUCTURAL

- THE CONTRACTOR SHOULD PROVIDE ADEQUATE TEMPORARY BRACING AND
- SHORING WHEREVER ANY STRUCTURAL WORK IS INVOLVED.
 ALL THE EXISTING MEANS OF EGRESS FOR WORKERS OR OTHER PERSONNEL OF THE BUILDING ARE TO BE MAINTAINED CLEAR AND FREE OF ALL OBSTRUCTIONS. ALL THE EXISTING MEANS OF EGRESS FOR THE TENANTS OF THE BUILDING TO BE MAINTAINED CLEAR AND FREE OF ALL OBSTRUCTIONS, SUCH AS BUILDINGS MATERIAL, TOOLS, FTC.
- 4.3 STEEL TO BE ERECTED IN COMPLIANCE WITH O.S.H.A SUBPART 'R' REGULATIONS

5.0 SITE SPECIFIC NOTES

- ALL AREAS USED BY PUBLIC SHALL BE MAINTAINED FREE FROM SNOW, ICE, DEBRIS, EQUIPMENT, PROJECTIONS AND TOOLS THAT MAY CONSTITUTE SLIPPING, TRIPPING OR OTHER HAZARD
- PROVIDE GUARD RAILS AND PROTECTION AS REQUIRED DURING EXCAVATION
- MEANS OF EGRESS TO BE MAINTAINED AT ALL TIMES DURING EXCAVATION OPERATIONS. BEFORE THE START OF WORK, EACH DAY ALL SIDEWALK SHEDS AND SCAFFOLDS ARE
- TO BE INSPECTED BY THE INDIVIDUAL DESIGNATED BY THE OWNER OR PERMIT HOLDER AT THE END OF EACH WORK DAY, ALL FLAMMABLE MATERIALS ARE TO BE REMOVED. FROM THE JOB SITE AND PROPERLY STORED AS PER CHAPTER 33 OF THE NEW YORK
- CITY BUILDING CODE UNLESS APPROVED BY FDNY/DOB. 5.6 PROVIDE ADEQUATE FLAG PERSON TO DIRECT PEDESTRIAN AND VEHICLE TRAFFIC WHEN TRAFFIC IS INTERRUPTED FOR ANY REASON
- 5.7 PLYWOOD PADS SHALL BE PROVIDED UNDER ALL DUMPSTER CONTAINERS TO PROTECT THE STREETS AND SIDEWALKS.
- ALL SIDEWALK SHEDS ARE TO BE HEAVY DUTY DESIGN.
- 5.9 THERE WILL BE NO STORAGE OF MATERIALS OR DEBRIS ON THE MATERIAL/PERSONAL HOIST PLATFORM
- 5.10 ALL SCAFFOLDS MUST BE INSPECTED BY A COMPETENT PERSON PRIOR TO USE.
- 5.11 ALL STEEL ERECTION SHOULD BE DONE AS PER CODE OF FEDERAL REGULATIONS: NEW STEEL ERECTION STANDARD SURPART 'R' 1926 750
- 5.12 BURNING AND WELDING SHOULD BE DONE AS PER NEW YORK CITY FIRE DEPARTMENT REQUIREMENTS
- ALL ASPECTS OF SECTION BC 3319 OF THE NEW YORK CITY BUILDING CODE
- FOR ONSITE INSPECTION OF CRANES, DERRICKS AND CABLEWARE SHALL BE MET. 5.13 IT WILL BE REQUIRED TO PLACE PROPERLY SECURED AND SAFE LADDERS INTO THE EXCAVATION OR TO THE CELLAR WHEN THE FOLINDATION IS COMPLETE ADDITIONALLY THERE WILL BE SIMILAR LADDERS SECURED TO EACH FLOOR AS THE CONSTRUCTION PROCEEDS. STAIRS WILL BE INSTALLED APPROXIMATELY (3) THREE FLOORS BEHIND THE NEW DECK. THESE STAIRS AND LADDERS ARE FOR USE OF WORKMEN TO ACCESS AND EVACUATE IN AN EMERGENCY OR OTHERWISE.
- PROVIDE PROTECTION OF ROOFS, SKYLIGHTS AND OTHER ROOF OUTLETS OF ADJACENT BUILDINGS PER SECTION BC 3309 OF THE NEW YORK CITY BUILDING CODE.
- 5.15 CONTRACTOR IS RESPONSIBLE AND LIABLE TO EXTEND AND MARK ALL STANDPIPE SYSTEMS, SIAMESE CONNECTIONS, FIRE HYDRANT LOCATIONS, SUCH AS TO BE CLEARLY VISIBLE AND ACCESSIBLE
- 5.16 ALL UTILITY TRENCHES TO BE COVERED WITH STEEL PLATES DURING NON-WORKING HOURS AND PROTECTION ON EITHER SIDE WITH FENCING OR BARRICADES DURING WORKING HOURS ON STREET.
- SIDEWALK AND PARTIAL ROADWAY CLOSING AS REQUIRED DURING CONSTRUCTION WITH OBTAINING PROPER PERMITS FROM NEW YORK CITY DEPARTMENT OF TRANSPORTATION
- 5.18 WHEN TRAFFIC PEDESTRIAN BARRICADES ARE REQUIRED, THE CONTRACTOR SHALL DETERMINE THE NEEDS OF THE SITE AND FURNISH BARRICADES ACCORDINGLY.
- WHEN THE CRANE LIFTS MATERIAL OFF TRUCKS PARKED IN LOADING ZONE THERE SHALL BE A FLAGMAN AT EACH END OF THE PEDESTRIAN WALKWAY TO TEMPORARILY STOP THE PUBLIC FROM WALKING UNDER CRANE WHILE LOADS ARE LIFTED OVERHEAD
- 5.20 LOCAL LAW 41:
 - ALL THE WORKERS SHALL HAVE SUCCESSFULLY COMPLETED, WITH IN THE PAST 5 CALENDAR YEARS, A TEN HOUR COURSE APPROVED BY THE UNITED STATES DEPARTMENT OF LABOR OCCUPATIONAL SAFETY AND HEALTH ADMINISTRATION IN CONSTRUCTION INDUSTRY SAFETY AND HEALTH, OR BY THE COMMISSIONER COVERING SUBSTANTIALLY THE SAME MATERIAL. SUCCESSFUL COMPLETION OF SUCH TRAINING COURSE SHALL BE EVIDENCED BY
 - a. PRESENTATION OF A BONA FIDE COURSE COMPLETION CARD.

 - c. A TRAINING ROSTER, ATTENDANCE RECORD OR OTHER DOCUMENTATION FROM CERTIFIED TRAINER PENDING THE ISSUANCE OF SUCH CARD.
 - d. OTHER VALID PROOF WHICH MAY BE APPROVED BY THE COMMISSIONER, SLICH EVIDENCE SHALL BE READILY AVAILABLE TO THE COMMISSIONER LIPON. REQUEST AND A STATEMENT THAT ALL WORKERS EMPLOYED ON THE SITE WILL RECEIVE A SITE SPECIFIC SAFETY ORIENTATION PROGRAM. THIS PROGRAM SHALL INCLUDE A REVIEW OF ANY HAZARDOUS ACTIVITIES TO BE PERFORMED. ALL WORKERS MUST ATTEND SUCH A PROGRAM NO LATER THAN SEVEN DAYS AFTER COMMENCING THEIR EMPLOYMENT.

6.0 MATERIAL HANDLING PLAN (as per RS18-7 SECTION 26.7) THIS WILL PERTAIN TO ALL RACK AND PINION HOISTS NOT JUST PERSONAL HOISTS

- BEFORE A LOADED BOOM IS SWUNG OVER A HOIST. THE HOIST MUST BE BROUGHT DOWN TO ITS LOWEST LEVEL, AND EVERYONE MUST EXIT THE HOIST.
- AT NO TIME CAN ANY CONSTRUCTION EQUIPMENT COME WITHIN TWO FEET TO
- ANY PART OF THE HOIST (EXCLUDING SETUP AND JUMPING OF THE HOIST). AT ANY TIME IF ANY CONSTRUCTION EQUIPMENT COMES WITHIN FIFTEEN FÉET OF THE HOIST, A PROTOCOL MUST BE ESTABLISHED. (SEE BELOW) THIS IS A MINIMUM STANDARD: IF ANY EQUIPMENT IS TO BE USED WITH IN THE FIFTEEN FOOT BUFFER IT MUST BE INCLUDED IN THE PLACE.
- SIGNAL PERSONAL AND HOIST OPERATOR MUST BE IN RADIO COMMUNICATION WITH EACH OTHER DURING OPERATIONS WITHIN FIFTEEN FEET OF THE HOIST. WHENEVER A PIECE OF CONSTRUCTION EQUIPMENT COMES WITHIN FIFTEEN FEET
- OF THE HOIST AT LEAST ONE SIGNAL PERSON MUST BE ASSIGNED TO THAT OPERATION
- IF A LOADED BOOM IS SWUNG OVER A HOIST, SEE OPTION ONE, AND WHEN THE LOAD IS OFF THE BOOM, THE SIGNAL PERSON LETS THE HOIST OPERATOR KNOW THAT THEY CAN PRECEDE AS NORMAL
- CONSTRUCTION EQUIPMENT THAT WILL BE PRESENT DURING COURSE OF CONSTRUCTION ARE: CONCRETE PUMPS, CONCRETE TRUCKS, MOBILE CRANE, BOOM TRUCKS, BOBCAT, DELIVERY TRUCKS.

7.0 FIRE SAFETY

- ALL BUILDING MATERIALS STORED AT THE CONSTRUCTION SITE AND / OR ANY AREA OF THE BUILDING ARE TO BE SECURED IN A LOCKED AREA. ACCESS TO SUCH ARFA ARF TO BE CONTROLLED BY OWNER OR GENERAL CONTRACTORS.
- ALL THE MATERIAL TO BE STORED SHALL BE STORED IN AN ORDERLY FASHION
- 7.3 ALL THE FLAMMABLE MATERIAL SHALL BE KEPT TIGHTLY IN THEIR RESPECTIVE CONTAINERS. SUCH MATERIALS SHALL BE KEPT AWAY FROM THE HEAT. ALL THE FLAMMABLE MATERIALS SHALL BE STORED IN AN AREA WITH THE
- ADEQUATE VENTILATION. ALL THE POWER IS TO BE SHUT OFF WHERE THERE IS EXPOSED WIRING.
- ALL THE ELECTRICAL POWER IN THE CONSTRUCTION AREA WITH EXCEPTION OF
- EMERGENCY LIGHTING IS TO BE SHUT OFF AT THE END OF THE WORK SHIFT. THE CONTRACTOR WILL BE AT ALL TIMES MAKE SURE THERE IS NO LEAKAGE OF NATURAL GAS OR FLAMMABLE GAS IN THE BUILDING.
- 7.8 ALL THE FIRE SAFETY AND THE EGRESS REQUIREMENTS AS PER CHAPTER 33 OF THE NEW YORK CITY BUILDING CODE, NEW YORK CITY FIRE DEPARTMENT REQUIREMENT SHALL BE ADHERED TO AS WELL AS THE PROJECT SAFFTY PLAN
- THE CONTRACTOR SHALL COMPLY WITH ALL APPLICABLE RULES REGARDING FIRE SAFETY EQUIPMENT ON SITE AS WELL AS PROVIDING THE TRAINED MANPOWER TO SHOW BASIC PREVENTION SKILLS.
- 7.10 DUST WILL BE CONTROLLED.
- DEBRIS, DIRT AND DUST IS TO A MINIMUM AND WILL BE CONFINED TO THE IMMEDIATE CONSTRUCTION AREA
- DEBRIS, DIRT AND DUST IS TO BE CLEANED UP AND REMOVED IN A TIMELY MANNER
- SIAMESE HOSE CONNECTIONS SHALL BE KEPT FREE FROM OBSTRUCTIONS AND SHALL BE MARKED WITH A METAL SIGN READING STANDPIPE SIAMESE CONNECTIONS AND LIT BY A RED LIGHT AT NIGHT.

8.0 NOTIFICATIONS INCIDENTS NOTIFICATION

AS PER 3310.8.2.1(7) OF THE NEW YORK CITY BUILDING CODE, SITE SAFETY COORDINATORS, DESIGNATED PERSONS AND SITE SAFETY MANAGERS MUST IMMEDIATELY REPORT INCIDENTS TO THE BUILDING DEPARTMENT A CALL MUST BE MADE TO THE CALL CENTER 212-393-2128.

- BEST NOTIFICATIONS:
- 24 HOURS BEFORE WORK STARTS, ON COMPANY LETTER HEAD, SEND A LETTER OF
- NOTIFICATION TO THE BEST SQUAD. 3310.8.2 NOTIFICATION. THE SITE SAFETY REPRESENTATIVE SHALL IMMEDIATELY NOTIFY THE DEPARTMENT DIRECTLY BY CALLING 212-566-3199, IF HE OR SHE DISCOVERS ANY OF THE FOLLOWING CONDITIONS IN THE ROUTINE PERFORMANCE OF THE JOB:
 - 1. A PERSON IS OPERATING A CRANE, DERRICK OR HOISTING EQUIPMENT ON THE SITE WITHOUT A PERMIT AND REFUSES TO DESIST FROM OPERATING THE FOUIPMENT:
 - 2. A CRANE IS BEING OPERATED BY AN UNLICENSED OPERATOR AND SUCH UNLICENSED OPERATOR REFUSES TO DESIST FROM OPERATING THE CRANE;
- NO FLAGPERSON IS PRESENT DURING CRANE OPERATION WHERE REQUIRED BY
- 4. SIDEWALK SHEDS REQUIRED BY THE SITE SAFETY PLAN ARE NOT IN PLACE DURING CONSTRUCTION OR DEMOLITION ACTIVITY;
- PERMITS HAVE NOT BEEN ISSUED FOR THE SIDEWALK SHEDS:
- 6. THE DESIGNER AND/OR SUPPLIER OF SIDEWALK SHEDS HAS NOT CERTIFIED THAT THE SHEDS HAVE BEEN ERECTED IN ACCORDANCE WITH THE APPROVED PLANS: OR
- . THERE HAS BEEN AN ACCIDENT INVOLVING THE PUBLIC, OR PRIVATE OR PUBLIC PROPERTY

3306.3 NOTIFICATION.

THE PERMIT HOLDER SHALL NOTIFY THE DEPARTMENT AND ADJOINING BUILDING OWNERS PRIOR TO THE COMMENCEMENT OF FULL AND PARTIAL DEMOLITION. OPERATIONS IN ACCORDANCE WITH SECTIONS 3306.3.1 AND 3306.3.2. 3306.3.1 NOTIFICATION OF THE DEPARTMENT.

THE PERMIT HOLDER SHALL NOTIFY THE DEPARTMENT VIA PHONE OR ELECTRONICALLY, AT LEAST 24 HOURS, BUT NO MORE THAN 48 HOURS PRIOR TO THE COMMENCEMENT OF SUCH WORK

3306.3.2 NOTIFICATION OF ADJOINING PROPERTY OWNERS.

ADJOINING PROPERTY OWNERS SHALL BE NOTIFIED OF UPCOMING DEMOLITION OPERATIONS IN WRITING NOT LESS THAN 10 DAYS PRIOR TO THE SCHEDULED STARTING DATE OF THE DEMOLITION. THE WRITTEN NOTICE SHALL PROVIDE A DESCRIPTION OF THE WORK TO BE PERFORMED, THE TIMEFRAME AND SCHEDULE, AND CONTACT INFORMATION OF THE PERSON CAUSING THE DEMOLITION AND OF THE DEPARTMENT EXCEPTION:

PARTIAL DEMOLITION OPERATIONS LIMITED TO THE INTERIOR COMPONENTS OF THE BUILDING WHERE MECHANICAL DEMOLITION EQUIPMENT, OTHER THAN HANDHELD

9.0 SPECIAL INSTRUCTIONS

- INSTRUCTION TO REQUEST START OF WORK
- FOR DEMOLITION ONLY:
- A CALL TO CALL CENTER 212-227-4416 24 HOURS BEFORE START OF WORK. FOR EXCAVATION ONLY;
- A CALL TO CALL CENTER 212-227-4416 24 HOURS BEFORE START OF WORK. FOR ALL SUSPENDED SCAFFOLDING:
- NOTIFICATION MUST BE CALLED IN TO THE CALL CENTER 24 HOURS BEFORE START OF WORK AND AT TIME OF REMOVAL. THE NUMBER IS 212-393-2550.
- FOR ALL OTHER SITE SAFETY JOBS; 24 HOURS BEFORE WORK STARTS OF WORK, ON COMPANY LETTER HEAD, SEND A LETTER VIA EMAIL OF NOTIFICATION TO THE SCAFFOLD SAFETY TEAM AND

A COPY OF THE PW2. SSTSWSSSREMOVAL@BUILDINGS.NYC.GOV.

LEGEND:

PROPERTY LINE SIAMESE RED LIGHT FOR CONSTRUCTION FENCE €®3**....** SIAMESE INDICATION RES OM, FIRE HYDRANT GUARDRAII $\cancel{\sim}$ W) CHAIN LINK FENCE FLAGMAN AS REQUIRED -LADDER · · · · · · NETTING Р PHONE STANDPIPE WITH RISER MESH ON TOP OF 4 РМ PARKING METER PLYWOOD FENCE **---**Ω SHEETING & SHORING PEDESTRIANS WALKWAY TIMBER BARRIERS ر ک TRFF PLASTIC BARRIER MAIL BOX FILED WITH WATER SIGN POLE CONCRETE BARRIER b HEAVYDUTY LIGHT POLE SIDEWALK SHED HIGH RISE SHED EXIT 르보 OVERHEAD PROTECTION MATERIAL HOIST OUTRIGGER REAM ROOF PROTECTION SUSPENDED SCAFFOLD C-HOOK VERTICAL NETTING SUSPENDED SCAFFOLD PIPE SCAFFOLDS WITH HORIZONTAL NETTING SAFETY NETTING **EXISTING FOUNDATION** FOUNDATION WALL WALL TO BE REMOVED

9.0 SPECIAL INSTRUCTIONS (continued)

- CLOSE OUT INSTRUCTIONS
- PARTIAL REMOVING SIDEWALK SHEDS REQUIRES AN AMENDED PLAN, NOTIFICATION TO THE BEST SQUAD AND AN INSPECTION BY THE BEST SQUAD
- PERMANENTLY REMOVING SIDEWALK SHEDS REQUIRES NOTIFICATION TO THE BEST SQUAD AND AN INSPECTION BY THE BEST SQUAD
- REMOVAL OF SITE SAFETY REQUIRES NOTIFICATION TO THE BEST SQUAD AND AN INSPECTION BY THE BEST SQUAD

THE WORK WILL COMPLY WITH ALL APPLICABLE SECTION OF CHAPTER 33 OF THE NYC 2014 BUILDING CODE AND ALL OSHA 1926 STANDARDS FOR CONSTRUCTION

Site Safety Plan for: 200 AMSTERDAM AVE **NEW YORK. NY**

Owner

AMSTERDAM AVE REDEVELOPMENT A 11 TIMES SQUARE NEW YORK, NY 10036 PH:201-592-1311 ATTN:VICTOR CIVIDINI

Safety Engineer/Designer

Major Building Consulting 21 W 38th Street, 11th Floor New York, NY 10018 Ph: 646-626-7373 Attn: Sandeep Gunnala

Architect/Engineer ELKUS / MANFREDI ARCHITECTS


25 DRYDOCK AVENUE BOSTON, MA 02210 Ph: 617-426-1300 Attn: HOWARD F ELKUS LICENCE: 018768

Contractor

Pavarini McGovern LLC 770 Broadway New York, NY 10003 Ph: 212-907-0900 Attn: Eric McGovern Proj Super: A.B. Olevic - Lic 1660

Site Safety Manager

Major Building Consulting 21 W 38th Street, 11th Floor New York, NY 10018 Ph: 646-626-7373 SSM TO BE DETERMINED

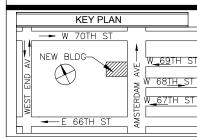

PREPAI

MRJOR BUILDING CONSUL CONSTRUCTION CODE & SAFETY EXPERT 21 WEST 38TH ST, 11TH FL TEL: 646-626-7373

PROJECT: New Building At 51 Stories 200 AMSTERDAM AVE New York, NY 10024, 642' HT Block 1158, Lot 133, CB 107 Job # 122887224, BIN: 1030358

SIGNS, NOTES & LEGEND

DRAWING TITLE:

SEAL & SIGNATURE




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FILE NUMBER: 2 DRAWN BY: F.K.

CHECK BY: S.G.


200 AMSTERDAM



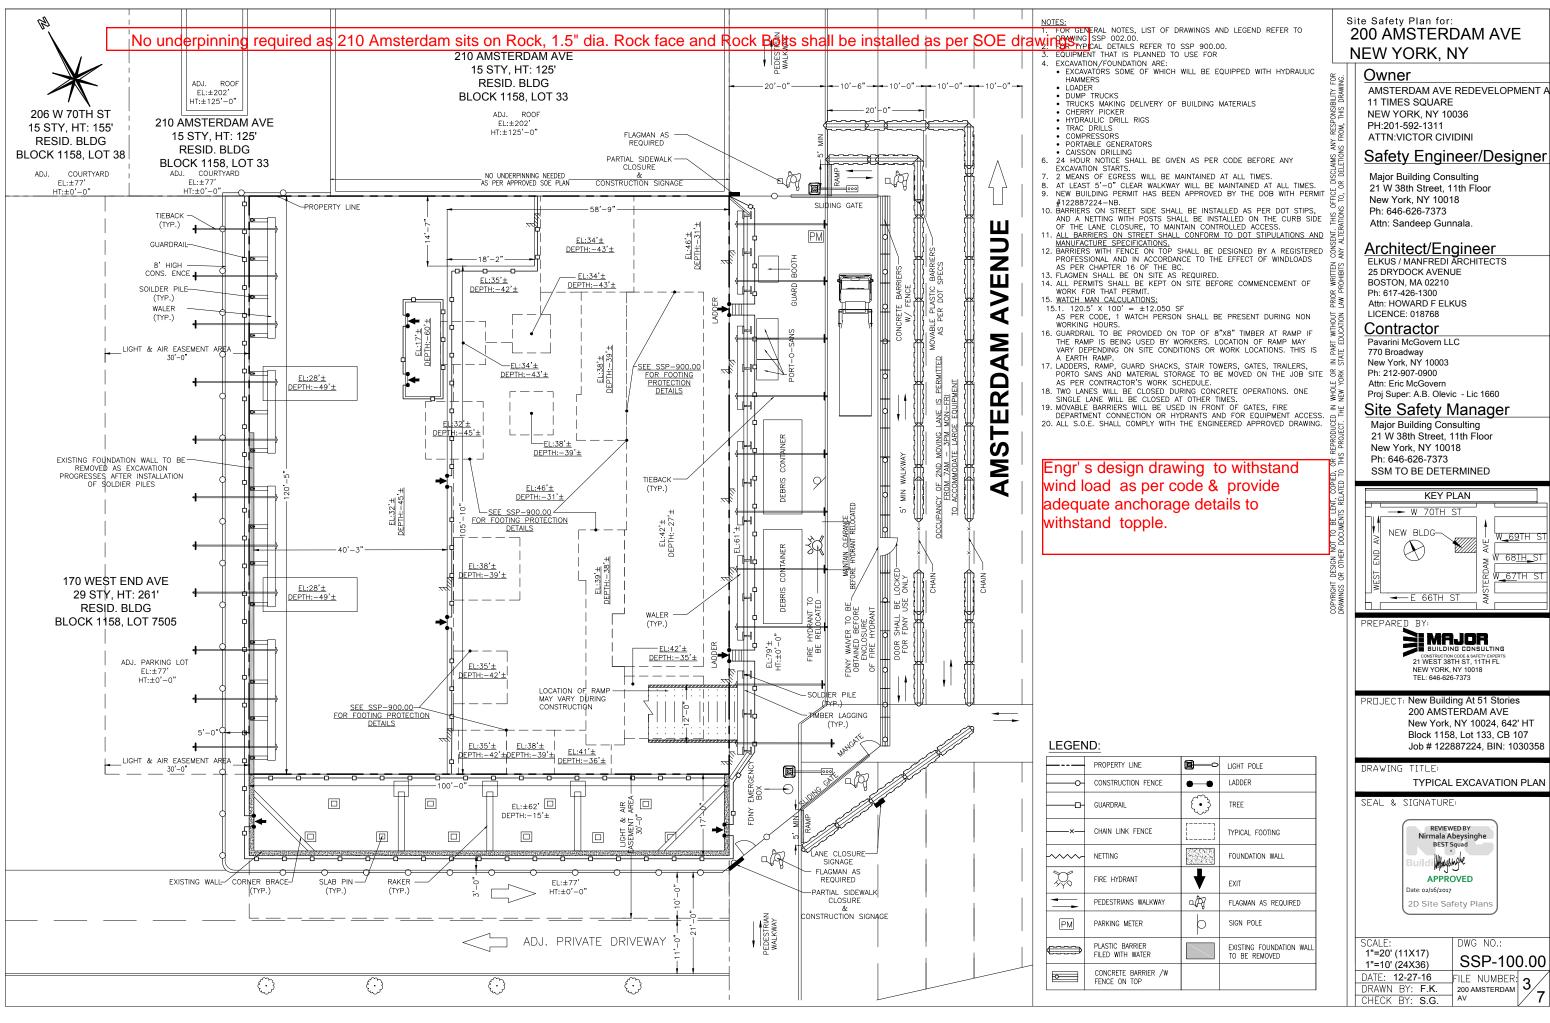

Job # 122887224, BIN: 1030358

SCALE:	DWG NO.:
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1"=10' (24X36)	SSP-100.00
DATE: 12-27-16	FILE NUMBER: 3/
DRAWN BY: F.K.	
CHECK BY: S.G.	AV /

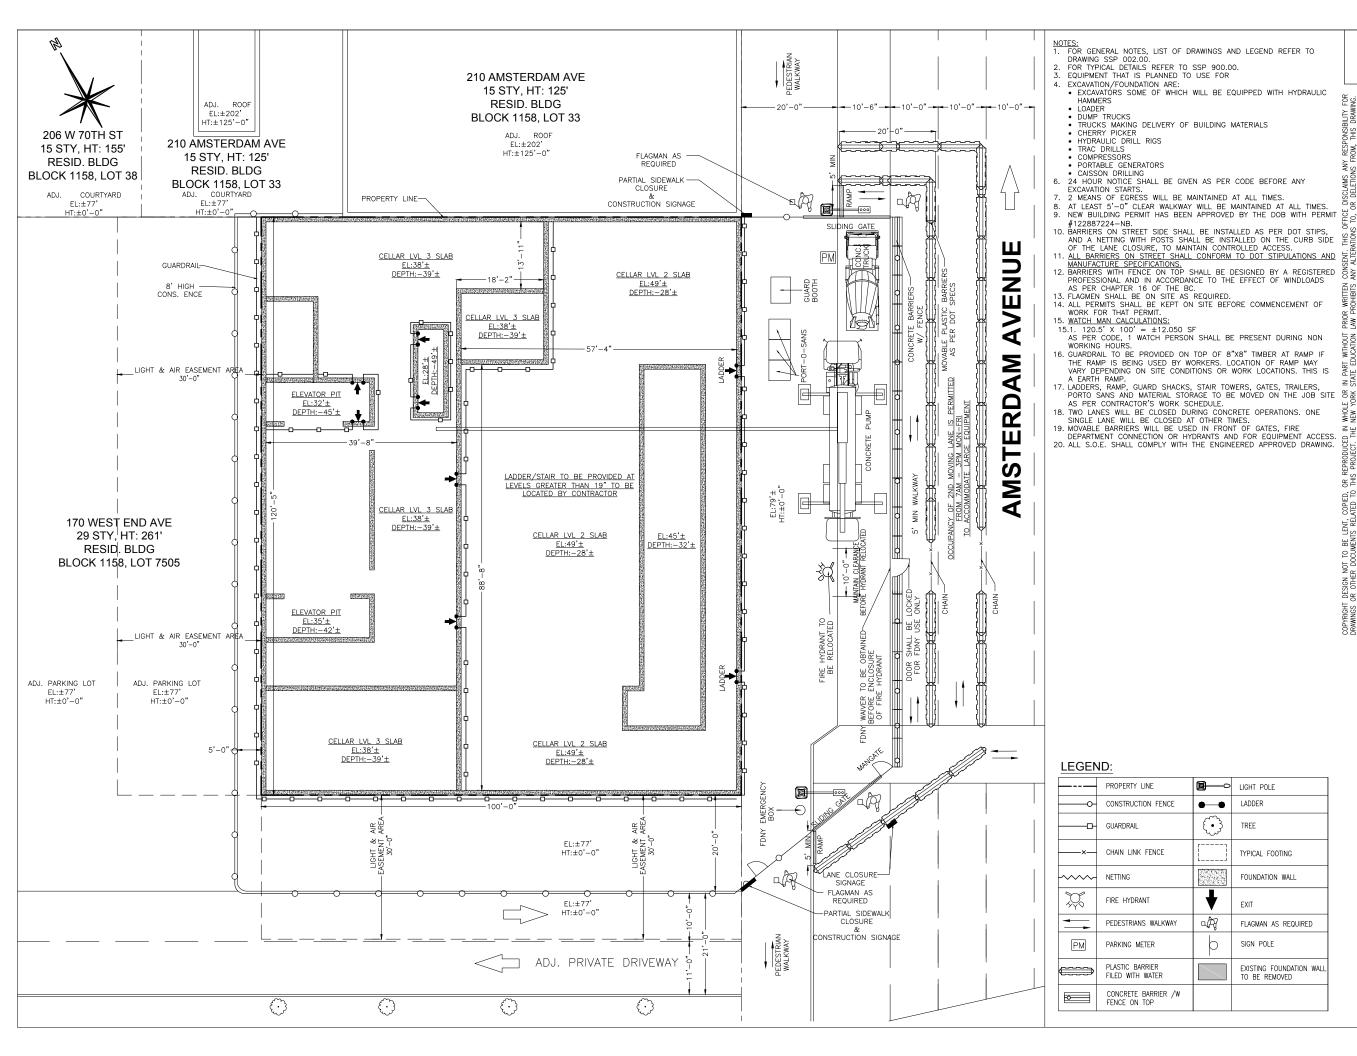

Site Safety Plan for: 200 AMSTERDAM AVE NEW YORK, NY

<u>Owner</u>

AMSTERDAM AVE REDEVELOPMENT A 11 TIMES SQUARE NEW YORK, NY 10036 PH:201-592-1311 ATTN:VICTOR CIVIDINI

Safety Engineer/Designer

Major Building Consulting 21 W 38th Street, 11th Floor New York, NY 10018 Ph: 646-626-7373 Attn: Sandeep Gunnala.

Architect/Engineer


ELKUS / MANFREDI ARCHITECTS 25 DRYDOCK AVENUE BOSTON, MA 02210 Ph: 617-426-1300 Attn: HOWARD F ELKUS LICENCE: 018768

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Site Safety Manager

Major Building Consulting 21 W 38th Street, 11th Floor New York, NY 10018 Ph: 646-626-7373 SSM TO BE DETERMINED



PARED BY:

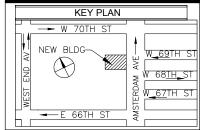SIMBJOR
BUILDING CONSULTING

CONSTRUCTION CODE & SAFETY EXPERTS 21 WEST 38TH ST, 11TH FL NEW YORK, NY 10018 TEL: 646-626-7373


PROJECT: New Building At 51 Stories 200 AMSTERDAM AVE
New York, NY 10024, 642' HT
Block 1158, Lot 133, CB 107
Job # 122887224, BIN: 1030358

DRAWING TITLE:
FOUNDATION PLAN CELLAR LVL 3

SEAL & SIGNATURE:



SCALE:	DWG NO.:
1"=20' (11X17) 1"=10' (24X36)	SSP-110.00
DATE: 12-27-16	FILE NUMBER: 1
DRAWN BY: F.K.	200 AMSTERDAM 🏲 🖊 💂
CHECK BY: S.G.	AV /

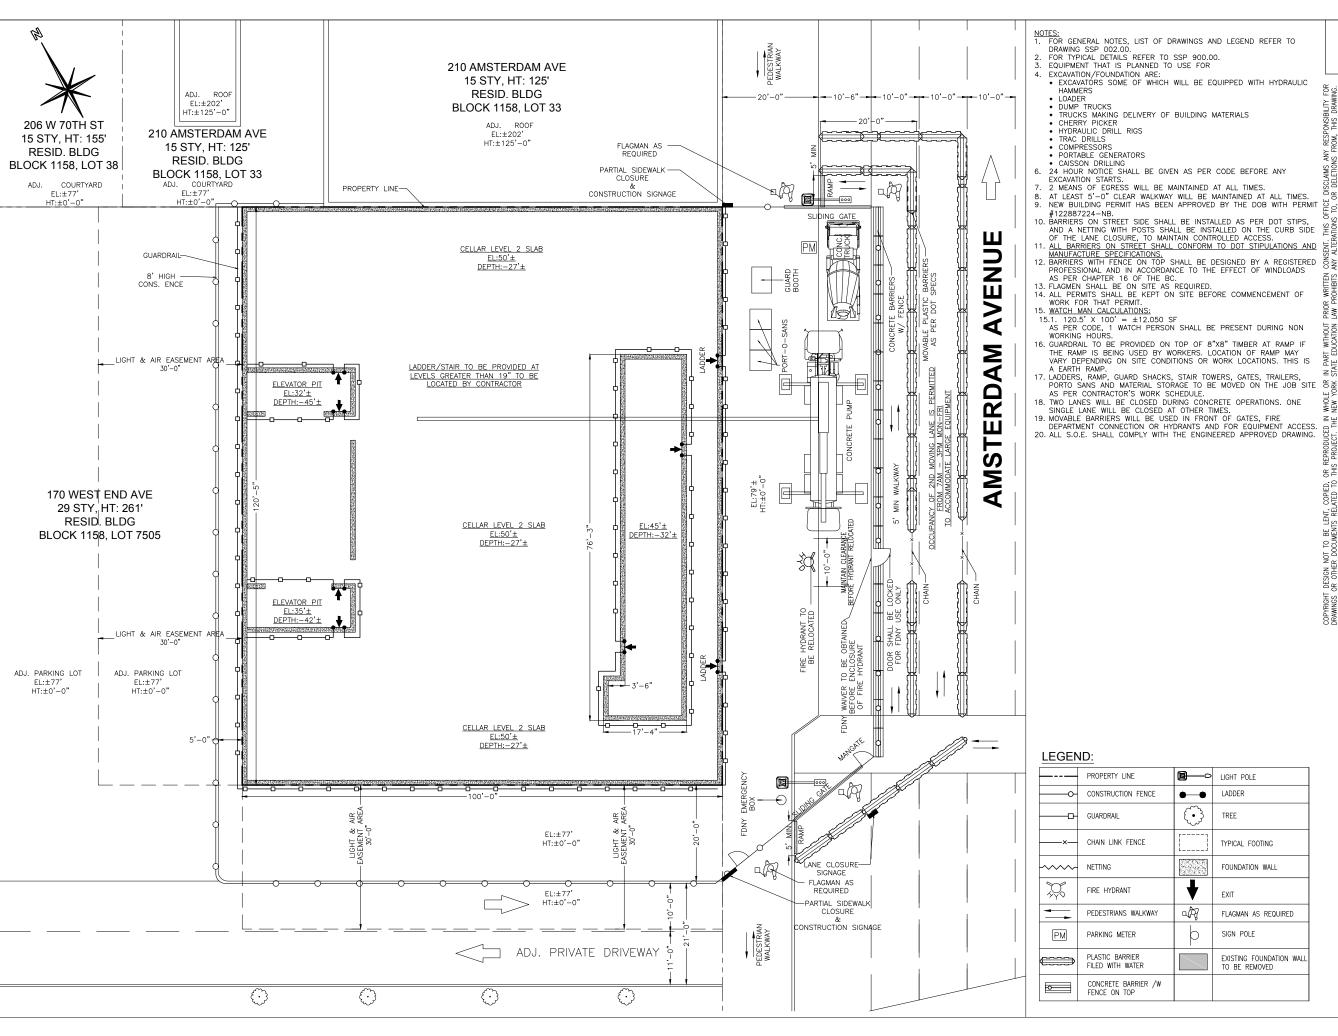

Site Safety Plan for: 200 AMSTERDAM AVE NEW YORK, NY

<u>Owner</u>

AMSTERDAM AVE REDEVELOPMENT A 11 TIMES SQUARE NEW YORK, NY 10036 PH:201-592-1311 ATTN:VICTOR CIVIDINI

Safety Engineer/Designer

Major Building Consulting 21 W 38th Street, 11th Floor New York, NY 10018 Ph: 646-626-7373 Attn: Sandeep Gunnala.

Architect/Engineer


ELKUS / MANFREDI ARCHITECTS 25 DRYDOCK AVENUE BOSTON, MA 02210 Ph: 617-426-1300 Attn: HOWARD F ELKUS LICENCE: 018768

<u>Contractor</u>

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Site Safety Manager

Major Building Consulting 21 W 38th Street, 11th Floor New York, NY 10018 Ph: 646-626-7373 SSM TO BE DETERMINED

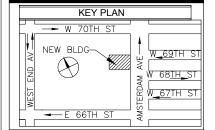

REPARED BY:

HAJOR BUILDING CONSULTING

CONSTRUCTION CODE & SAFETY EXPERTS
21 WEST 38TH ST, 11TH FL
NEW YORK, NY 10018
TEL: 646-626-7373

PROJECT: New Building At 51 Stories


200 AMSTERDAM AVE New York, NY 10024, 642' HT Block 1158, Lot 133, CB 107 Job # 122887224, BIN: 1030358

DRAWING TITLE: FOUNDATION PLAN CELLAR LVL 2

SEAL & SIGNATURE:



SCALE:	DWG NO.:
1"=20' (11X17) 1"=10' (24X36)	SSP-120.0
DATE: 12-27-16	FILE NUMBER: 5
DRAWN BY: F.K.	
CHECK BY: S.G.	AV

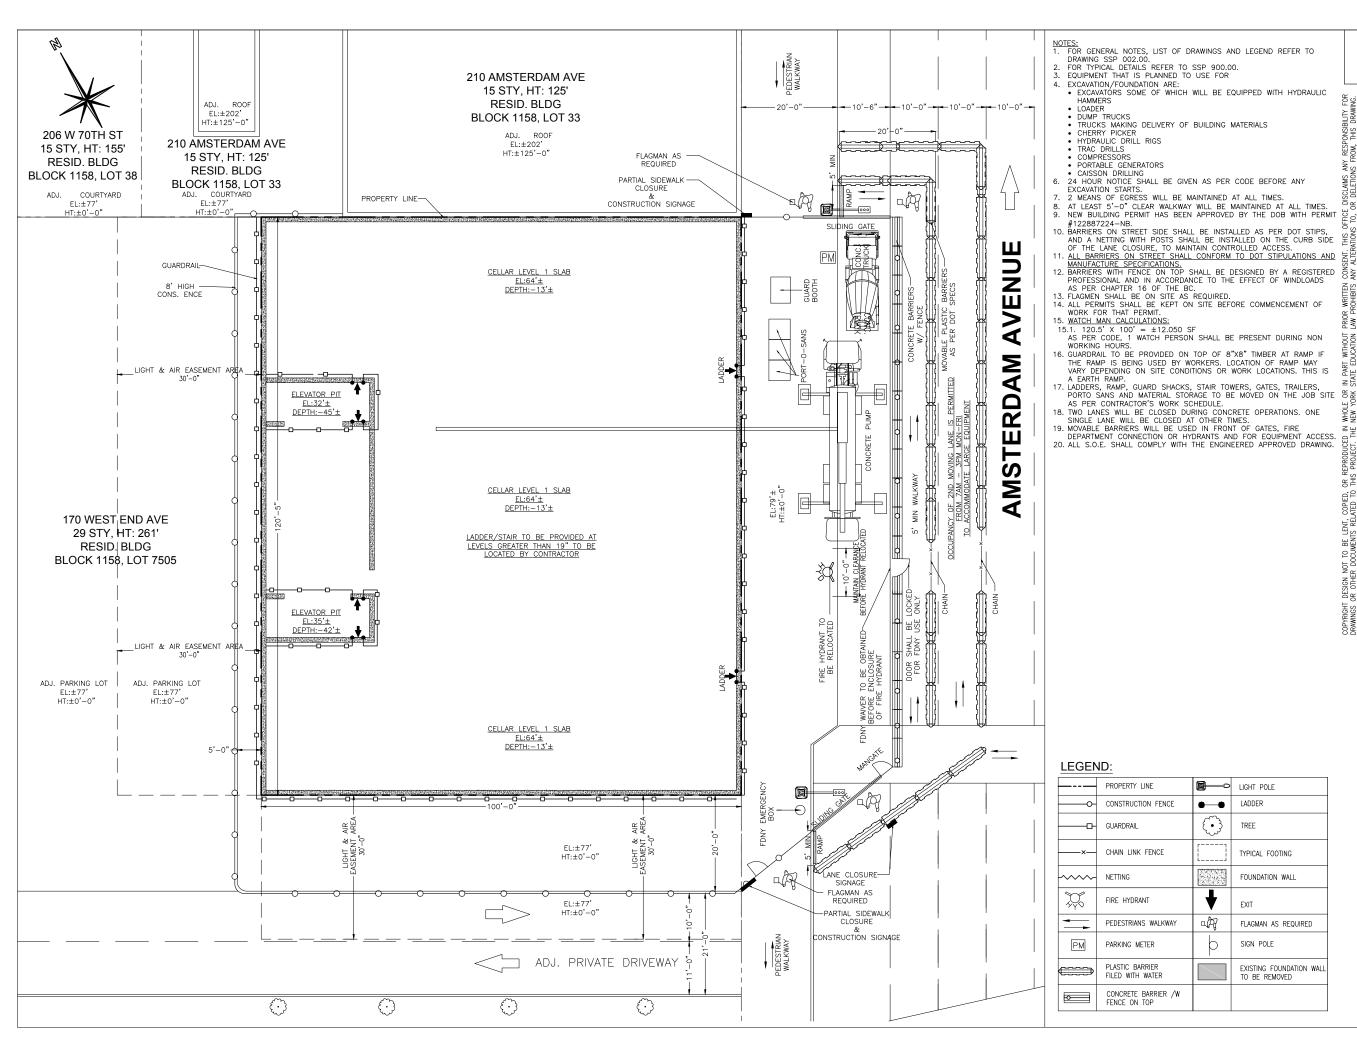

Site Safety Plan for: 200 AMSTERDAM AVE NEW YORK, NY

<u>Owner</u>

AMSTERDAM AVE REDEVELOPMENT A 11 TIMES SQUARE NEW YORK, NY 10036 PH:201-592-1311 ATTN:VICTOR CIVIDINI

Safety Engineer/Designer

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Architect/Engineer


ELKUS / MANFREDI ARCHITECTS 25 DRYDOCK AVENUE BOSTON, MA 02210 Ph: 617-426-1300 Attn: HOWARD F ELKUS LICENCE: 018768

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Site Safety Manager

Major Building Consulting 21 W 38th Street, 11th Floor New York, NY 10018 Ph: 646-626-7373 SSM TO BE DETERMINED



REPARED BY:

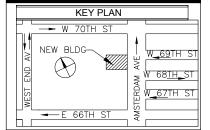HAJOR BUILDING CONSULTING

CONSTRUCTION CODE & SAFETY EXPERTS 21 WEST 38TH ST, 11TH FL NEW YORK, NY 10018 TEL: 646-626-7373


PROJECT: New Building At 51 Stories 200 AMSTERDAM AVE
New York, NY 10024, 642' HT
Block 1158, Lot 133, CB 107
Job # 122887224, BIN: 1030358

DRAWING TITLE: FOUNDATION PLAN CELLAR LVL

SEAL & SIGNATURE:



	DWG NO.:
1"=20' (11X17) 1"=10' (24X36)	SSP-130.00
DATE: 12-27-16	FILE NUMBER: c /
DRAWN BY: F.K.	FILE NUMBER: 6
CHECK BY: S.G .	AV /

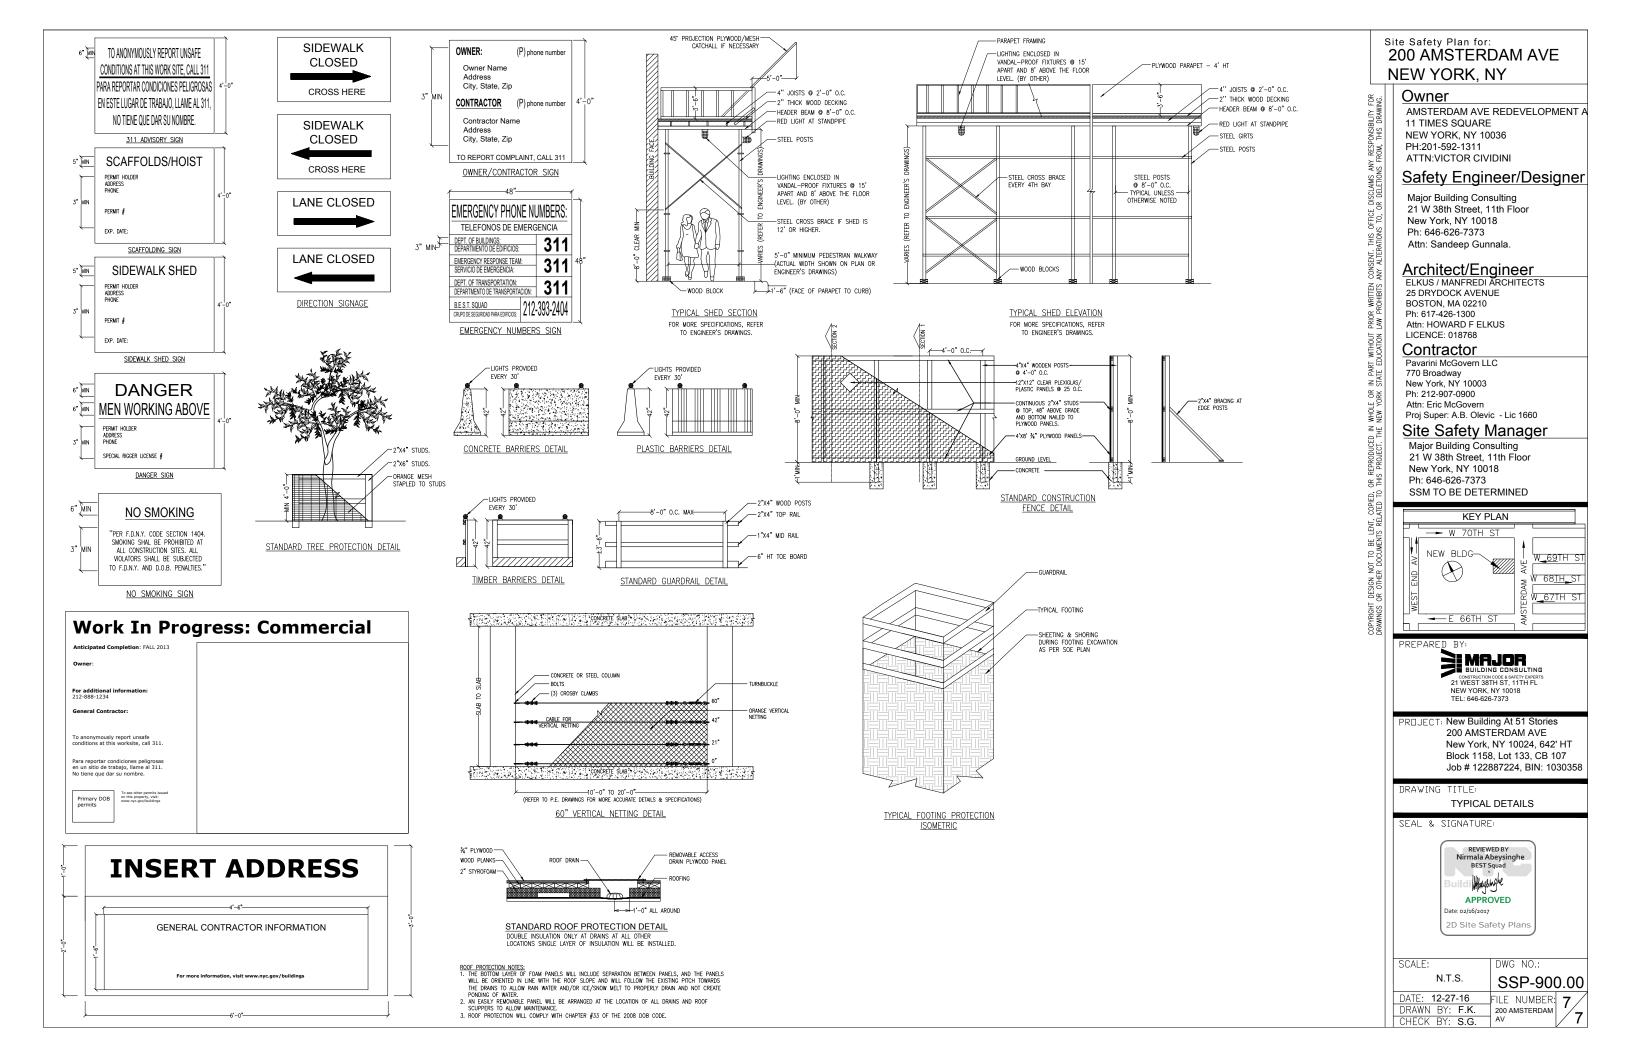



SITE SAFETY PLAN FOR A 51 STORY NEW BUILDING AT 200 AMSTERDAM AVE NEW YORK, NY 10024

BLOCK: 1158

MAP NO .

PROPOSED HEIGHT: ZONING DIST:

JOB APPLICATION NO.:

BOX 9c CHECKED:

CONSTRUCTION CLASSIFICATION:

OCCUPANCY CLASSIFICATION:

B.I.S. REQUIRED INFO ENTERED:

LOT: 133

BIN: 1030358

122887224 - NB

YES

YES

I-A: 3 HOUR PROTECTED - NON COMBUST

R-2- RESIDENTIAL: APARTMENT HOUSES

R8-GENERAL RESIDENCE DISTRICT

CB: 107

PREPARED BY.

RELATED APPLICATIONS:

122887224 - NB 122887224 - FENCE 122887224 - STRUCTURAL 122887224 - SOE

122887224 — FOUNDATION 122887224 — PLUMBING SIDEWALK SHED TO BE FILED SEMBLICATION CODE & SAFETY EXPERTS

21 W 38TH STREET, 11TH FLOOR NEW YORK, NY 10018 PH: 646-626-7373 ATTN: FEHMI KAYA.

DRAWING LIST SSP-001.03 TITLE SHEET x | x | x | x | SSP-002:00 GENERAL NOTES SSP-100.01 TYPICAL EXCAVATION PLAN SSP-110.01 TYPICAL FOUNDATION PLAN CELLAR LVL 3 | X | X | TYPICAL FOUNDATION PLAN CELLAR LVL 2 SSP-120.01 | X | X SSP-130.01 TYPICAL FOUNDATION PLAN CELLAR LVL 1 SUPERSTRUCTURE BELOW 75' SSP-200.00 SSP-210.00 SUPERSTRUCTURE ABOVE 75' SSP-220.00 SPECIAL OPERATION SITE LAYOUT x WEST & NORTH ELEVATION х SSP-300.00 SSP-310.00 EAST & SOUTH ELEVATION SSP-320.00 TOWER CRANE ERECTION SSP-900.00 TYPICAL DETAILS

B.E.S.T SQUAD ST. LUKE'S ROOSEVELT HOSPITAL CENTER B.E.S.T: AMBULANCE: 2 LAFAYETTE STREET, 12TH FLOOR 1000 TENTH AVENUE NEW YORK, NY 10007 NEW YORK, NY 10019 (212) 602-0406 212-523-4000 MANHATTAN BOROUGH OFFICE ENGINE 40 LADDER 35 D.O.B.: FIRE HOUSE: 280 BROADWAY 131 AMSTERDAM AVENUE **EMERGENCY** MANHATTAN, NY 10007 NEW YORK, NY (212) 393-2614 212-570-4240 BUREAU OF PERMIT MANAGEMENT AND **TELEPHONE** D.O.T.: GENERAL INFORMATION AND COMPLAINTS: CONSTRUCTION CONTROL (OCMC) 55 WATER STREET MAJOR BUILDING CONSULTING NEW YORK, NY 10041 MAJOR BUILDING CONSULTING **NUMBERS** (212) 839-9588 21 WEST 38TH ST, 12TH FL NEW YORK, NY 10018 20TH PRECINCT POLICE PRECINCT HOUSE: P: (212) 683-7200 120 W 82ND ST NEW YORK, NY 10024 D.O.B. INCIDENTS REPORTING 212-602-0431 212-580-6411

Site Safety Plan for: 200 AMSTERDAM AVE NEW YORK, NY

Owner

AMSTERDAM AVE REDEVELOPMENT A 11 TIMES SQUARE NEW YORK, NY 10036 PH:201-592-1311 ATTN:VICTOR CIVIDINI

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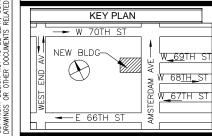
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Site Safety Manager

City Safety Compliance 21 W 38th Street, 11th Floor New York, NY 10018 Ph: 646-626-7373 SSM TO BE DETERMINED



PREPARED BY:

MRJOR
BUILDING CONSULTING
CONSTRUCTION CODE & SAFETY EXPERTS
21 WEST 38TH ST. 11TH FL

PROJECT: New Building At 51 Stories
200 AMSTERDAM AVE
New York, NY 10024, 642' HT
Block 1158, Lot 133, CB 107

Job # 122887224, BIN: 1030358

TEL: 646-626-7373


DRAWING TITLE:
TITLE SHEET

SEAL & SIGNATURE



SCALE:	DWG NO.:
N/A	SSP-001.03
DATE: 08-08-18	FILE NUMBER: 1
DRAWN BY: Y.Z.	200 AMSTERDAM

CHECK BY: F.K. AV

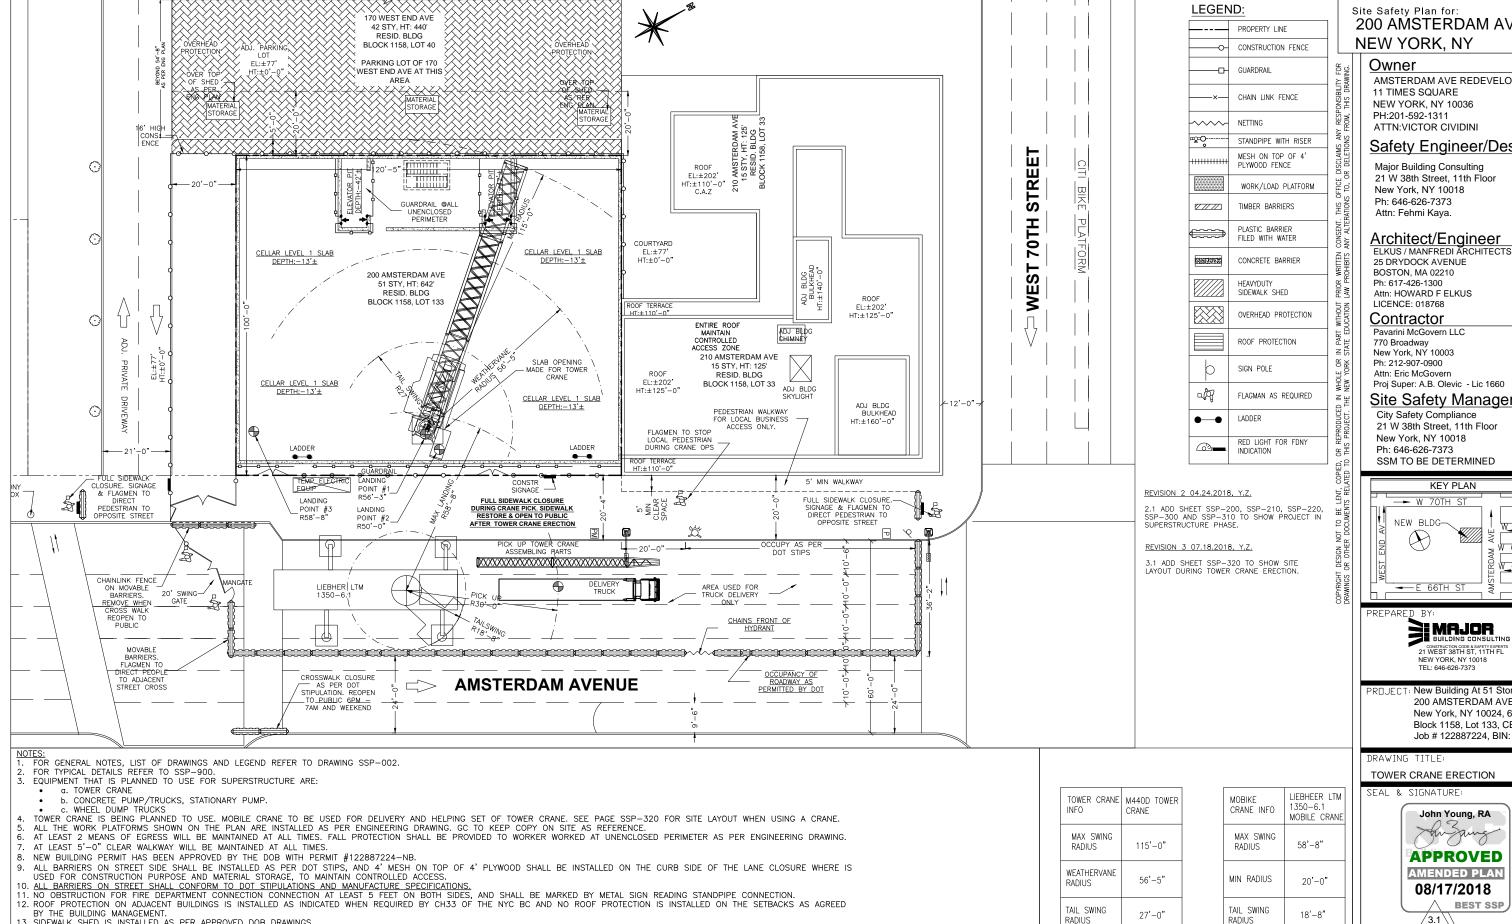

Site Safety Plan for: 200 AMSTERDAM AVE **NEW YORK. NY**

> AMSTERDAM AVE REDEVELOPMENT A 11 TIMES SQUARE NEW YORK, NY 10036 PH:201-592-1311 ATTN:VICTOR CIVIDINI

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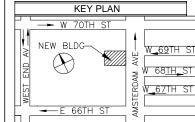
25 DRYDOCK AVENUE BOSTON, MA 02210 Ph: 617-426-1300 Attn: HOWARD F ELKUS LICENCE: 018768

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Site Safety Manager

City Safety Compliance 21 W 38th Street, 11th Floor New York, NY 10018 Ph: 646-626-7373 SSM TO BE DETERMINED



MAJOR BUILDING CONSULT

21 WEST 38TH ST, 11TH FL TEL: 646-626-7373

PROJECT: New Building At 51 Stories 200 AMSTERDAM AVE New York, NY 10024, 642' HT Block 1158, Lot 133, CB 107 Job # 122887224, BIN: 1030358

DRAWING TITLE:

TOWER CRANE ERECTION

SEAL & SIGNATURE



<u>/3.1</u>
SCALE:
1"=30' (11X17)
1"=15' (24X36)

CHECK BY: F.K.

027018

CN#'S

0913/17

CN#'S

SSP-320.00 FILE NUMBER: 7 DATE: **08-08-18** DRAWN BY: Y.Z. 200 AMSTERDAM

13. SIDEWALK SHED IS INSTALLED AS PER APPROVED DOB DRAWINGS.

14. WATCHMAN SHALL BE PRESENT ON SITE AT ALL TIMES ONLY DURING NON-WORKING HOURS.


15. FLAGMEN SHALL BE ON SITE AS REQUIRED. DOOR INSIDE PEDESTRIAN WALKWAY WILL BE CLOSED DURING CRANE PICK.


16. ALL PERMITS SHALL BE KEPT ON SITE BEFORE COMMENCEMENT OF WORK FOR THAT PERMIT.
17. OVERHEAD PROTECTION WILL BE INSTALLED AT ENTRY POINTS DURING STEEL ERECTION PHASE ONLY.


18. BARRIERS WITH FENCE ON TOP SHALL BE DESIGNED BY A REGISTERED PROFESSIONAL AND IN ACCORDANCE TO THE EFFECT OF WINDLOADS AS PER CHAPTER 16 OF THE BC..


19. OCCUPANCY OF 2 LANES AS PERMITTED BY DOT 24/7. OCUPANCY OF 3 LANES AS PERMITTED FOR LARGE EQUIPMENT USAGE ONLY. TIME AS PERMITTED BY DOT.


20. LADDERS, RAMP, GUARD SHACKS, STAIR TOWERS, GATES, TRAILERS, PORTO SANS AND MATERIAL STORAGE TO BE MOVED ON THE JOB SITE AS PER CONTRACTOR'S WORK SCHEDULE.

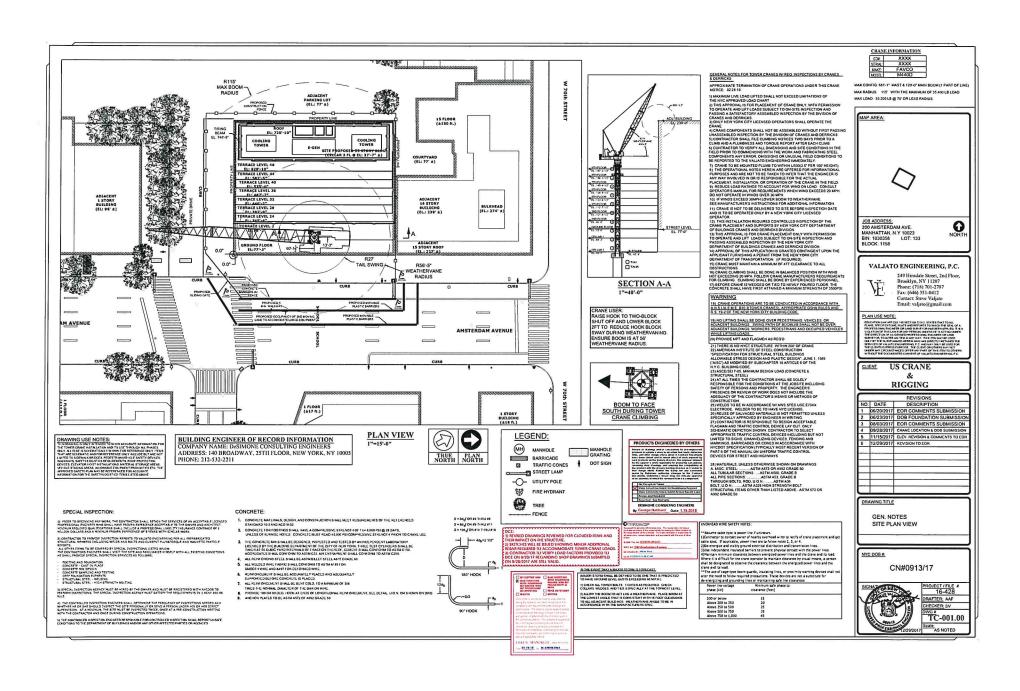


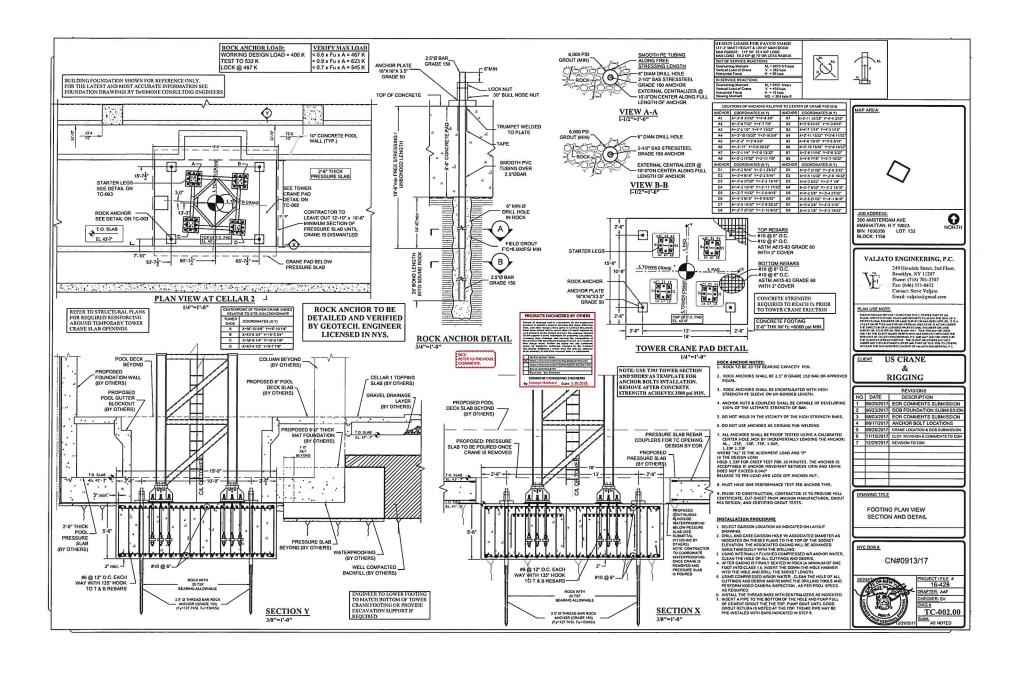


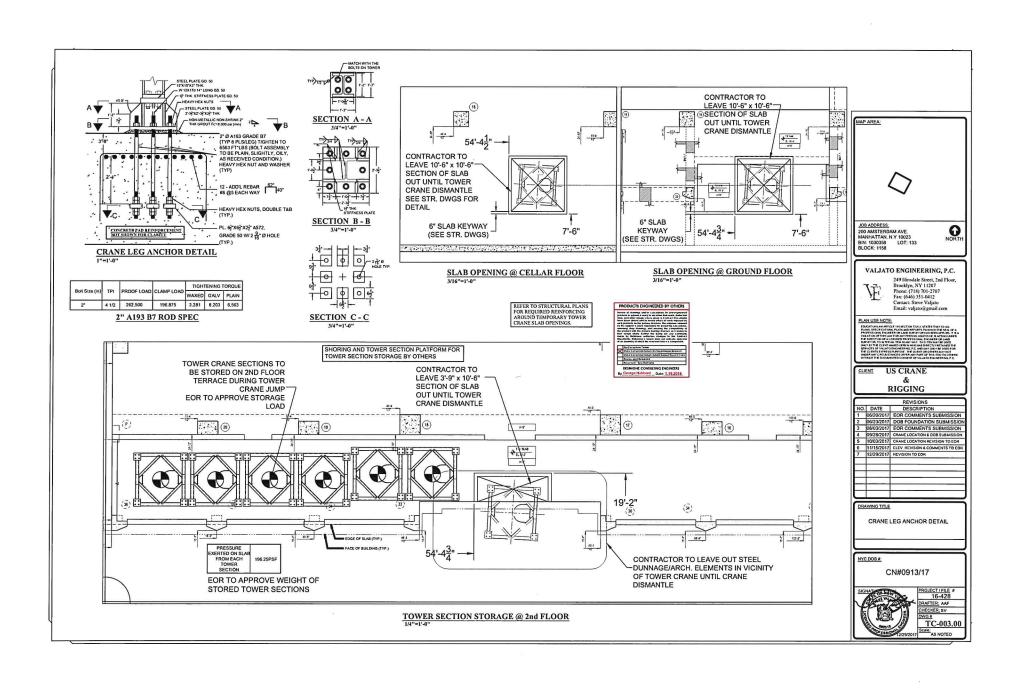


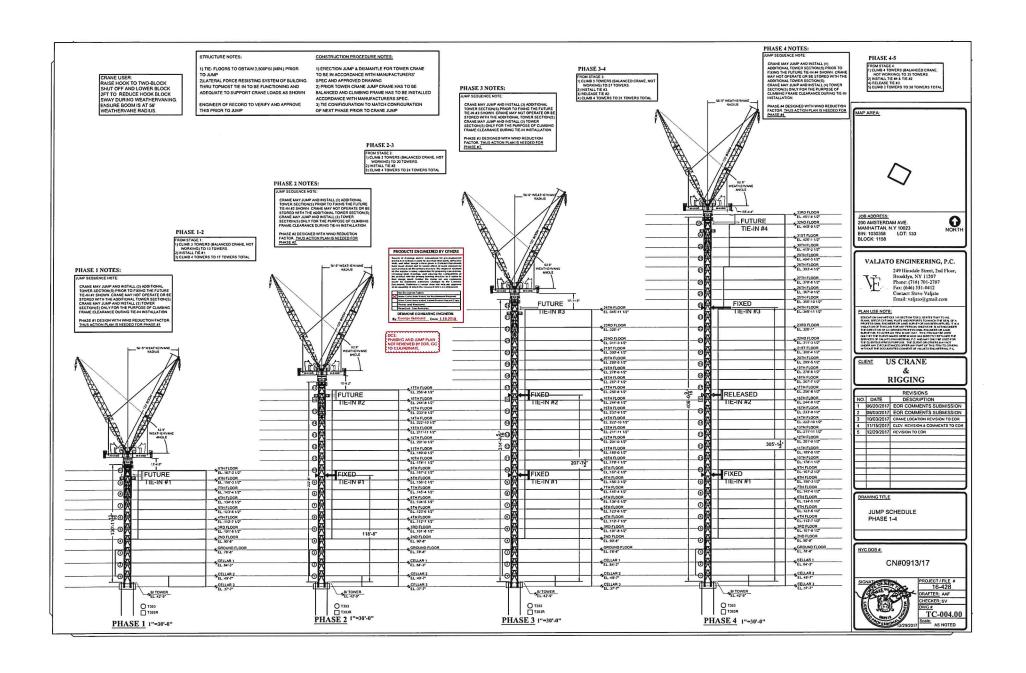

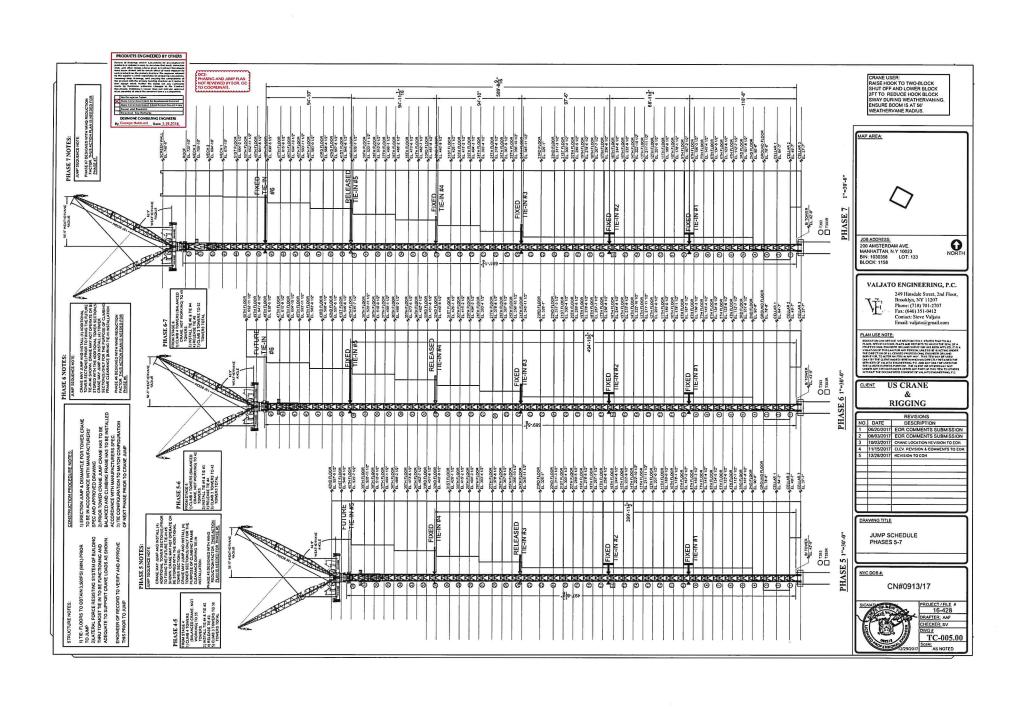

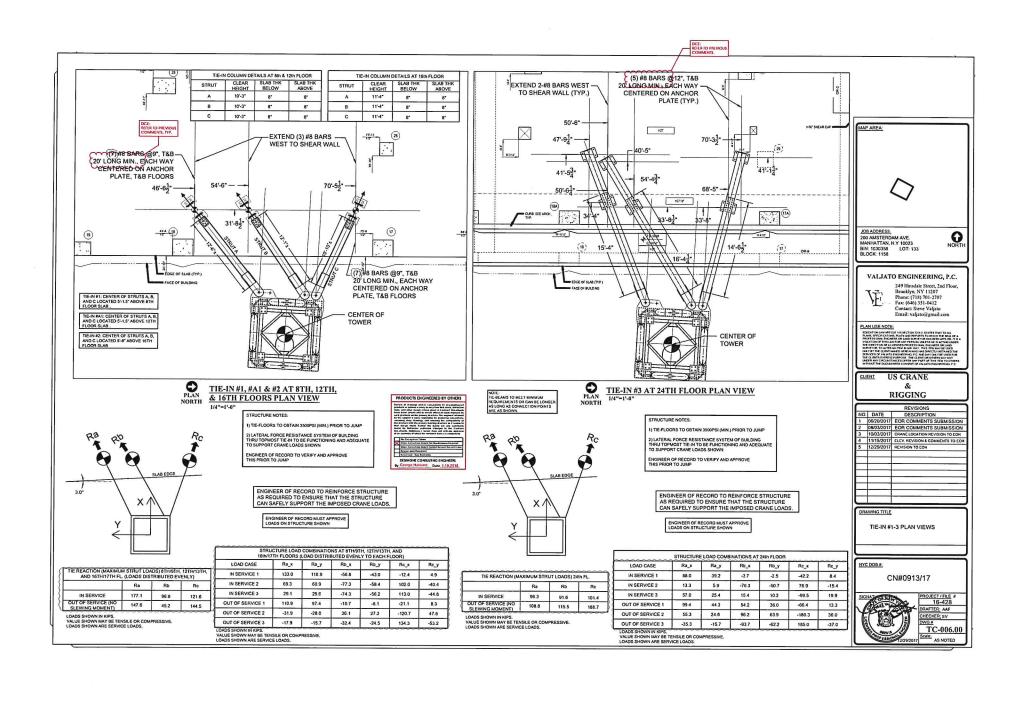

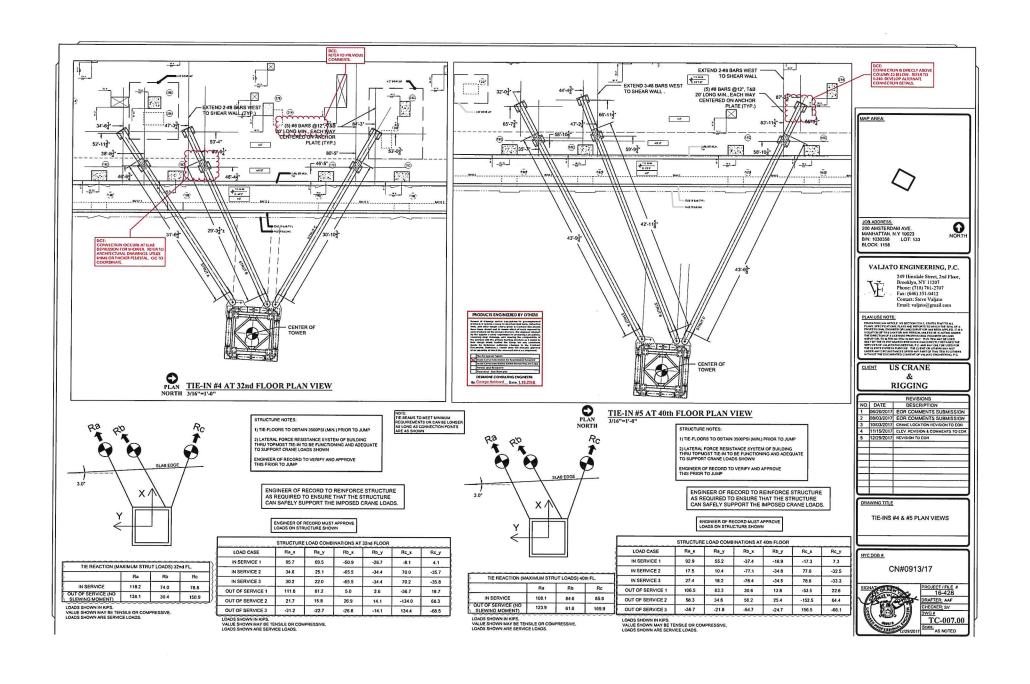

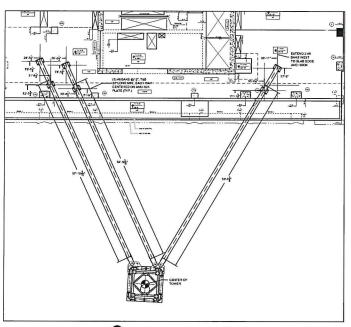

PLAN NORTH TIE-IN #6 AT 48TH FLOOR PLAN VIEW 1/8"=1'-0"

STRUCTURE NOTES:

1) TIE-FLOORS TO OBTAIN 3500PSI (MIN.) PRIOR TO JUMP

ENGINEER OF RECORD TO VERIFY AND APPROVE THIS PRIOR TO JUMP

ENGINEER OF RECORD TO REINFORCE STRUCTURE AS REQUIRED TO ENSURE THAT THE STRUCTURE CAN SAFELY SUPPORT THE IMPOSED CRANE LOADS.

ENGINEER OF RECORD MUST APPROVE LOADS ON STRUCTURE SHOWN

SLAB EDGE	Rc	
3.0°	_	3.0
Y		Y T

TIE REACTION (MA	XIMUM STRU	IT LOADS) 48	TH FL.
	Ra	Rb	Rc
IN SERVICE	103.2	69.3	73.1
OUT OF SERVICE (NO SLEWING MOMENT)	120.5	45.8	158.9

20000000	STRUCTURE	LOAD COMB	INATIONS AT	48th FLOOR		
LOAD CASE	Ra_x	Ra_y	Rb_x	Rb_y	Rc_x	Rc_)
IN SERVICE 1	91.3	48.1	-28.5	-14.8	-26.2	13.5
IN SERVICE 2	4.5	2.3	-61.5	-31.9	58.1	-30.0
IN SERVICE 3	22.5	11.8	-59.5	-30.8	65.0	-33.5
OUT OF SERVICE 1	106.6	56.2	31.5	16.3	-58.0	30.0
OUT OF SERVICE 2	83.2	43.9	40.7	21.1	-126.1	65.1
OUT OF SERVICE 3	-43.9	-23.1	-36.3	-18.8	141.2	-72.9

LOADS SHOWN IN KIPS.
VALUE SHOWN MAY BE TENSILE OR COMPRESSIVE.
LOADS SHOWN ARE SERVICE LOADS.

MAP AREA:



JOB ADDRESS: 200 AMSTERDAM AVE. MANHATTAN, N.Y 10023 BIN: 1030358 LOT: 133 BLOCK: 1158



VALJATO ENGINEERING, P.C.



249 Hinsdale Street, 2nd Floor, Brooklyn, NY 11207 Phone; (718) 701-2707 Fax: (646) 351-0412 Contact: Steve Valjato Email: valjato@gmail.com

PLAN USE NOTE:

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US CRANE CLIENT RIGGING

_		
		REVISIONS
NO.	DATE	DESCRIPTION
1	06/20/2017	EOR COMMENTS SUBMISSION
2	08/03/2017	EOR COMMENTS SUBMISSION
3	10/03/2017	CRANE LOCATION REVISION TO EOR
4	11/15/2017	ELEV. REVISION & COMMENTS TO EOR
5	12/29/2017	REVISION TO EOR
_		
_	-	

DRAWING TITLE

TIE-IN #6 PLAN VIEW


NYC DOB #:


CN#0913/17








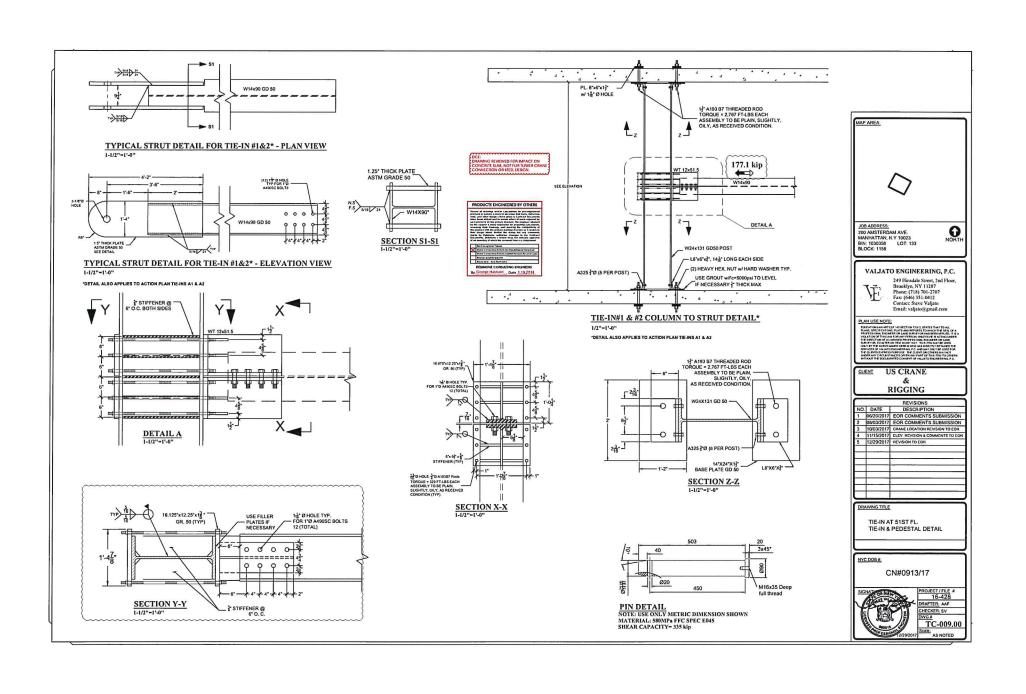

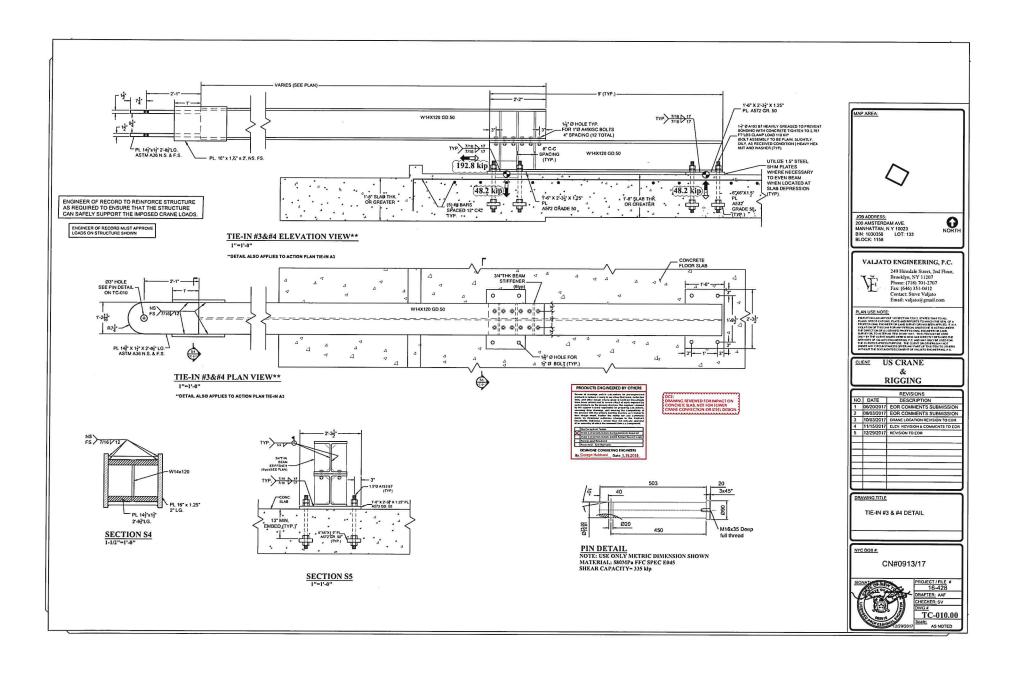

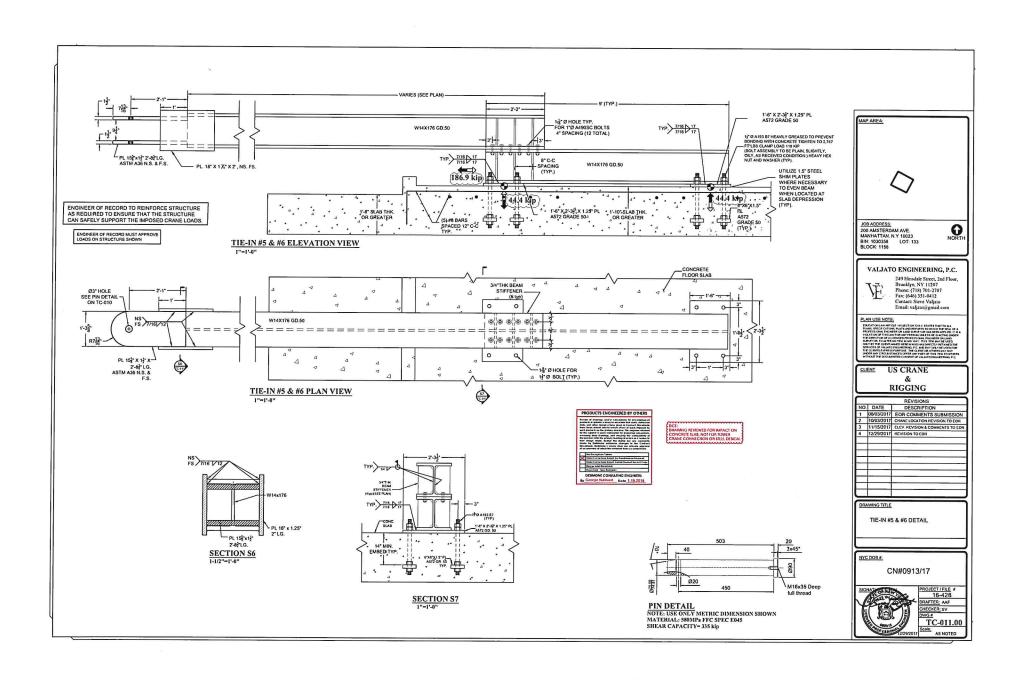

PLAN COMPONENTS WITH DESCRIPTION OF **ACTIONS AND REQUIREMENT IN ACCORDANCE** WITH NYC BC 2014 SECT 1618

1. THRESHOLD OF PREDICTED ENVIRONMENTAL LOADS
IF GROUND LEVEL WIND GUST ARE EXPECTED TO EXCEED 80 MPH THE FOLLOWING ACTION PLAN SHALL BE IMPLEMENTED (BASED ON NATIONAL WEATHER FORECAST SERVICE).

2. METHOD OF MONITORING ENVIROMENTAL LOADS
EQUIP WITH ANEMOMETER/WING SPEED METER THAT ALLOWS OPERATOR TO CONSTANTLY MONITOR THE WIND SPEED WHILE CRANE IS IN-SERVICE. CRANE SAFETY COORDINATOR IS TO CONSTANTLY MONITOR THE WEATHER FORECAST AND WIND SPEEDS WHILE CRANE IS

3. PARTY RESPONSIBLE FOR MONITORING LOADS AND DETERMINING IMPLEMENTATION OF ACTION PLAN CRANE USER & CRANE SAFETY COORDINATOR ARE RESPONSIBLE PARTIES FOR MONITORING LOADS AND DETERMINING IMPLEMENTATION OF ACTION PLAN.

4. PARTY RESPONSIBLE FOR EFFECTUATING THE ACTION PLAN CRANE USER & CRANE SAFETY COORDINATOR ARE RESPONSIBLE FOR EFFECTUATING THE

5. EVACUATION PROCEDURES
EVACUATION IS NOT APPLICABLE. NO EVACUATION REQUIRED.

6. SAFETY ZONE, STANDOFF DISTANCE OR STANDOFF PERIMETER NOT APPLICABLE. NO SAFETY ZONE REQUIRED

7. PREPARATION & REQUIREMENTS SO THAT TOWER CRANE MAY RESIST UNREDUCED

WIND FORCES
FOR WINDS PREDICTED ABOVE 80MPH, THE ACTION PLAN MUST BE IMPLEMENTED AS LISTED BELOW AND ALL ACTION MUST BE COMPLETED PRIOR TO THE HIGH WIND EVENT:


A. FOLLOW ACTION PLAN PROCEDURE LISTED FOR EACH PHASE.

B. CHECK ALL TOWER BOLTS. TIGHTEN AS REQUIRED. CHECK COLLAR, AND TIES.

8. PLAN TO PREVENT WIND-BORN DEBRIS
CRANE USER & CRANE SAFETY COORDINATOR TO ENSURE THAT CRANE HAS BEEN INSPECTED
FOR LOOSE ITEMS AND MATERIALS STORAGE AND ANY ITEMS NOT DIRECTLY FASTENED TO

9. VERIFICATION THAT THE DESIGN AND PROCEDURES SHALL NOT ADVERSELY IMPACT OTHER STRUCTURES. CRANE USER & CRANE SAFETY COORDINATOR ARE RESPONSIBLE THAT THERE ARE NO

OBSTRUCTION TO MOVING PARTS. IMPLEMENTATION OF ITEM 7 SHALL ENSURE THAT OTHER STRUCTURES ARE NOT ADVERSELY IMPACTED.

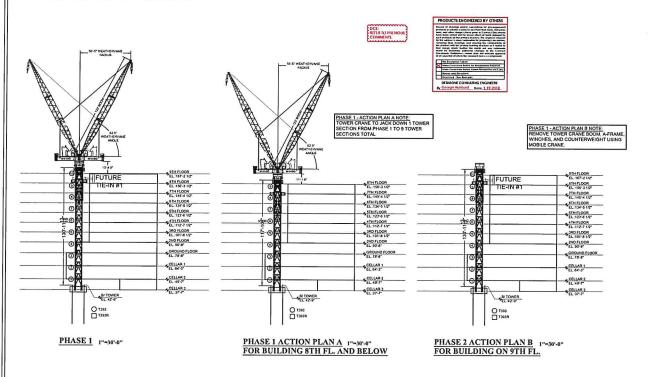

*IDIFLOOR FL 122 4 1/2 ****************** CHOLED FLOOR STREET LEVEL n 4177 SECTION A-A WHEN CRANE IS IN PHASE 1 ACTION PLAN A

1"-40'-0"

IAP AREA:

JOB ADDRESS 200 AMSTERDAM AVE. MANHATTAN, N.Y 10023 BIN: 1030358 LOT: 1 BLOCK: 1158 LOT: 133



VALJATO ENGINEERING, P.C.

249 Hinsdale Street, 2nd Floor, Brooklyn, NY 11207 Phone: (718) 701-2707 Fax: (646) 351-0412

PLAN USE NOTE:

US CRANE RIGGING

		REVISIONS
NO.	DATE	DESCRIPTION
1	10/03/2017	CRANE LOCATION REVISION TO EOR
2	11/15/2017	ELEV. REVISION & COMMENTS TO EOF
3	12/29/2017	REVISION TO EOR
	-	


JUMP SCHEDULE - PHASE 2 **ACTION PLANS**

NYC DOB #:

CN#0913/17



DRAFTER: AAF CHECKER: SV TC-012.00

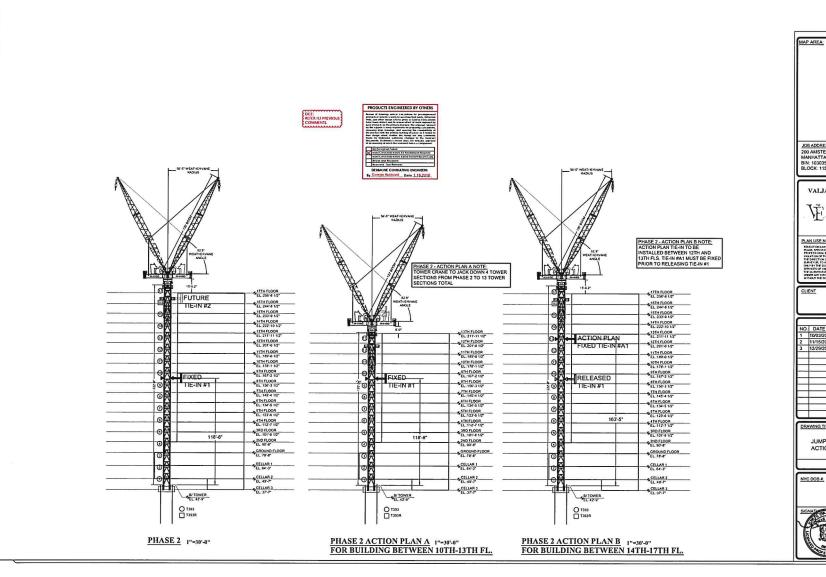



JOB ADDRESS: 200 AMSTERDAM AVE. MANHATTAN, N.Y 10023 BIN: 1030358 LOT: 133 BLOCK: 1158



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249 Hinsdale Street, 2nd Floor, Brooklyn, NY 11207 Phone: (718) 701-2707 Fax: (646) 351-0412 Contact: Steve Valjato Email: valjato⊕gmail.com

PLAN USE NOTE:

FOICATON IAW ARTGE 145 SECTION 77092, ST.
FAMIL SPECIFICATION, FLAT LAW REPORTS TO
PROFESSIONAL PROMPTING IT LAW SUPPLY
VOLATION OF THE LAW FOR ANY PERSON, LINES
THE DIRECTION OF ALL PROMPT PROMPTING.

US CRANE RIGGING

		REVISIONS
NO.	DATE	DESCRIPTION
1	10/03/2017	CRANE LOCATION REVISION TO EOR
2	11/15/2017	ELEV. REVISION & COMMENTS TO EOH
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-		
	-	

DRAWING TITLE

JUMP SCHEDULE - PHASE 2 ACTION PLANS

CN#0913/17



PROJECT / FILE # 16-428 DRAFTER: AAF CHECKER: SV TC-013.00 Scale: AS NOTED

