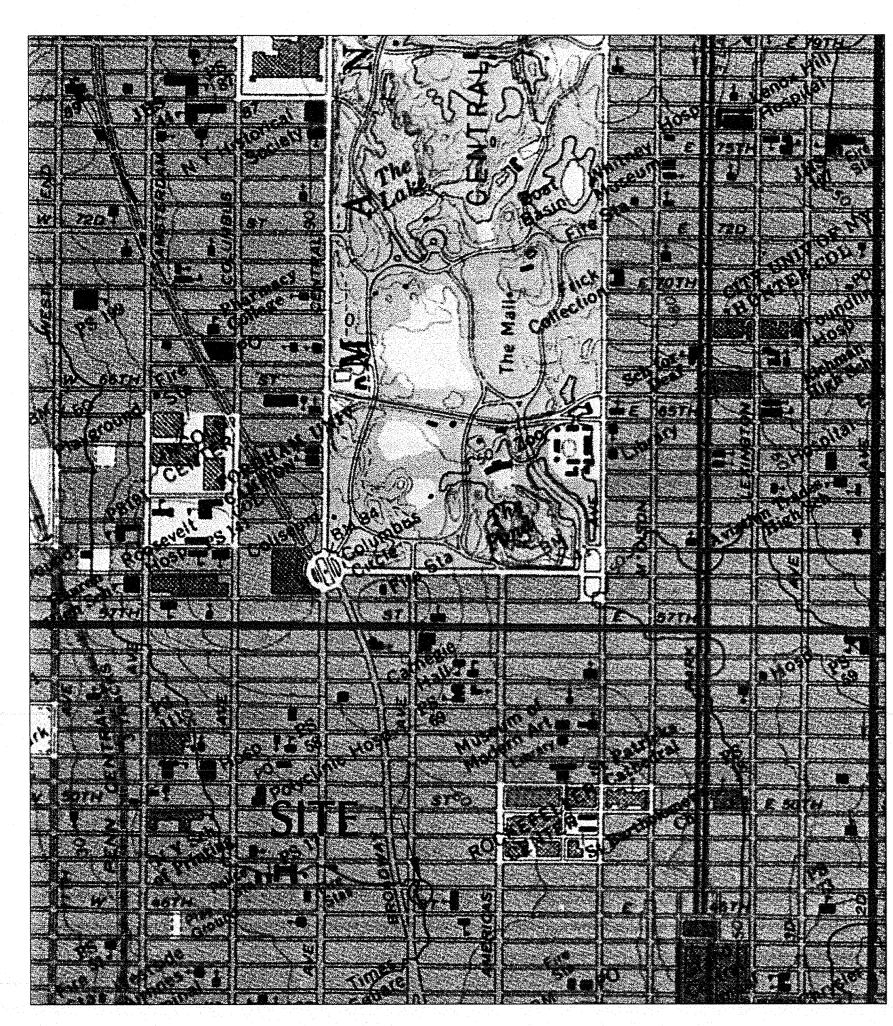
# 1568 BROADMAY NEW YORK, NEW YORK

# SUPPORT OF EXCAVATION

# LANGAN

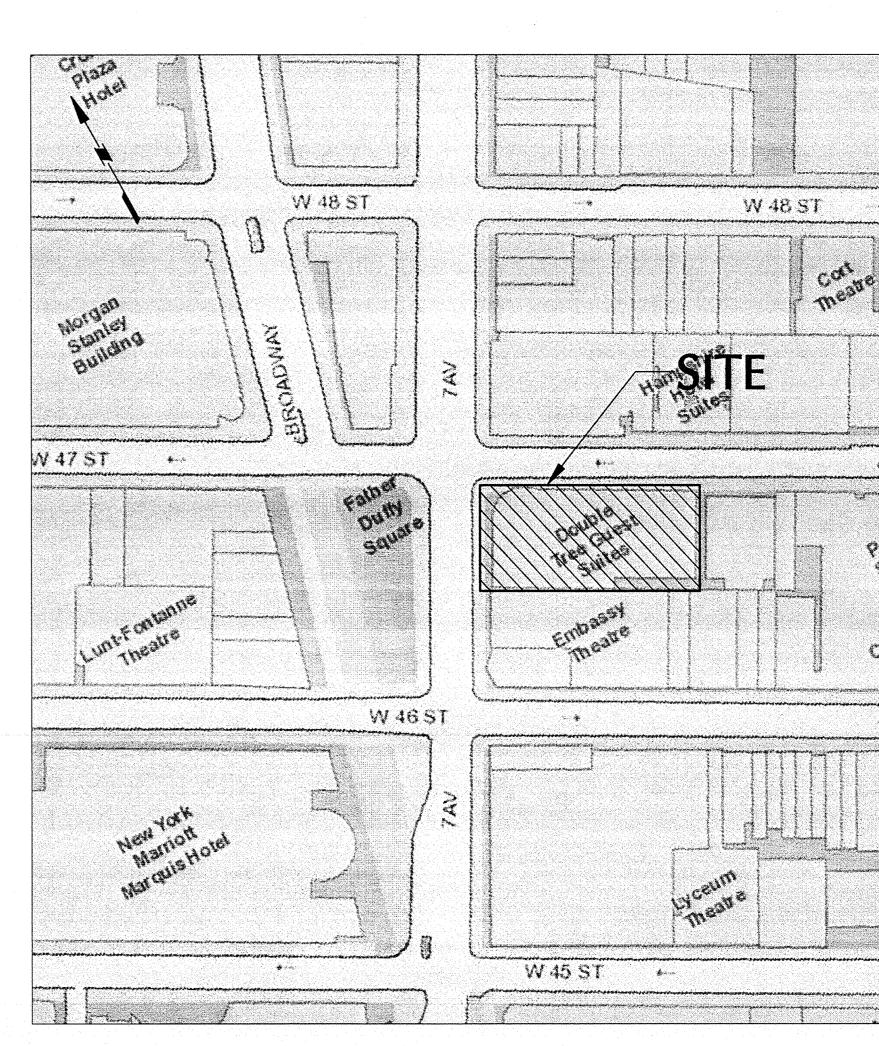
#### DRAWING LIST



SOURCE: USGS CENTRAL PARK AND BROOKLYN QUADRANGLE MAPS, 1968, PHOTOREVISED 1979.

**VICINITY MAP** 

DRAWING	TITLE
SOE-001	1568 BROADWAY PROJECT PHASING SHEET
SOE-002	SUPPORT OF EXCAVATION TITLE SHEET AND DRAWING LIST
SOE-003	SUPPORT OF EXCAVATION GENERAL NOTES
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SOE-104	SUPPORT OF EXCAVATION AND HOWARD SHAPIRO DEMOLITION PLAN
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SOE-301	NORTH DEMOLITION AND EXCAVATION: PART PLAN, ELEVATION AND SECTIONS
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SOE-304	SOUTH DEMOLITION AND EXCAVATION: PART PLAN, ELEVATION AND SECTIONS
SOE-305	SOUTH: PART PLAN, ELEVATION AND SECTIONS
SOE-306	WEST DEMOLITION AND EXCAVATION: PART PLAN, ELEVATION AND SECTIONS
SOE-307	WEST: PART PLAN, ELEVATION AND SECTIONS
SOE-401	SECTION 2: TRANSIT AUTHORITY STAGED EXCAVATION
SOE-402	SECTION 3: TRANSIT AUTHORITY STAGED EXCAVATION
SOE-403	SECTION 10: TRANSIT AUTHORITY STAGED EXCAVATION
SOE-404	SECTION 11: TRANSIT AUTHORITY STAGED EXCAVATION
SOE-501	SUPPORT OF EXCAVATION DETAILS
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SOURCE: NYCITY MAP - DOITT - CITY-WIDE GIS

SITE MAP

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11.10.2016	10	NYCTA SUBMISSION
10.28.2016	9	100% DESIGN DEVELOPMENT
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07.15.2016	7	50% DESIGN DEVELOPMENT
06.24.2016	6	TA FILING
05.18.2016	5	DEVELOPMENT REPORT
04.08.2016	4	100% SCHEMATIC DESIGN
02.17.2016	3	50% SCHEMATIC DESIGN
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1568 Broadway

New York, NY 10036

Sheet Title:

SUPPORT OF EXCAVATION TITLE SHEET

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#### **EXCAVATION SUPPORT GENERAL NOTES:**

- 1. NEW YORK CITY TRANSIT (NYCT) STANDARD NOTES PERTAIN TO THE NEW WORK WHERE APPLICABLE
- 2. NYCT APPROVAL OF FOUNDATION DRAWINGS IS REQUIRED BEFORE COMMENCING EXCAVATION AND INSTALLATION OF THE BRACING SYSTEM ADJACENT TO NYCT STRUCTURES.
- 3. CONTRACTOR SHALL OBTAIN APPROVAL FROM NYCT AND THE OWNERS ENGINEERS PRIOR TO RELOCATING AND BRACING TO FACILITATE FOUNDATION CONSTRUCTION.
- 4. CONTRACTOR TO SUPPORT EXISTING UTILITIES BETWEEN PROPERTY LIMIT AND NYCT STRUCTURES.
- 5. CONTRACTOR SHALL OBTAIN PERMISSION FROM ADJACENT BUILDING OWNER PRIOR TO START OF CONSTRUCTION NEAR ADJACENT BUILDINGS.
- 6. PRIOR TO START OF NEW WORK, PERFORM PRECONSTRUCTION INSPECTION OF ADJACENT NYCT SUBWAY. INSPECTION SHOULD BE DONE IN THE PRESENCE OF A NYCT INSPECTOR. LIMITS OF THE PRECONSTRUCTION INSPECTION OF THE TUNNEL SHALL EXTEND 50 FT BEYOND THE PROPERTY LINE.
- 7. IF CHANGED CONDITIONS AFFECTING THE WORK ARE FOUND, REVISED APPROVAL SHALL BE REQUIRED FROM THE NYCT.
- 8. NYCT APPROVAL OF FOUNDATION DRAWINGS IS REQUIRED BEFORE COMMENCING EXCAVATION AND INSTALLATION OF THE BRACING SYSTEM ADJACENT TO NYCT STRUCTURES.
- 9. CONTRACTOR SHALL OBTAIN APPROVAL FROM NYCT AND THE OWNERS ENGINEERS PRIOR TO RELOCATING AND BRACING TO FACILITATE FOUNDATION CONSTRUCTION.
- 10. CONTRACTOR TO SUPPORT EXISTING UTILITIES BETWEEN PROPERTY LIMIT AND NYCT STRUCTURES.
- 11. CONSTRUCTION FENCE AND SITE ACCESS SHOWN HERE ARE FOR REFERENCE ONLY. FINAL NYC DOT APPROVED LOCATIONS AND SITE LOGISTICS PLANS WILL BE PROVIDED BY THE CONTRACTOR.
- 12. TEMPORARY EXCAVATION SUPPORT IS DESIGNED FOR AN ALLOWABLE VERTICAL SURCHARGE OF 600 PSF ADJACENT TO WALL (PER NYCT).
- 13. CONTRACTOR SHALL OBTAIN PERMISSION FROM ADJACENT BUILDING OWNER PRIOR TO START OF CONSTRUCTION NEAR ADJACENT BUILDINGS.
- 14. EXCAVATION SHALL BE COMPLETED TO DEPTHS SHOWN ON THE EXCAVATION PLAN. EXCAVATIONS SHALL INCLUDE THE REMOVAL OF ALL SOIL, BOULDERS, AND MAN-MADE OBSTRUCTION WITHIN THE DEPTH OF THE EXCAVATION.
- 15. THE CONTRACTOR IS TO PREPARE A SITE LOGISTICS PLAN PRIOR TO START OF WORK, THE CONTRACTOR'S SITE LOGISTICS PLAN SHALL CONTAIN, AMONG OTHER ITEMS, SEQUENCING OF CONSTRUCTION ACTIVITIES. A CONSTRUCTION SCHEDULE WITH CRITICAL PATH, FENCING REQUIREMENTS, SITE SIGNAGE, SITE SAFETY, AND SITE ACCESS MANAGEMENT
- 16. THE DESIGN ENGINEER RESPONSIBLE FOR THE SUPPORT OF EXCAVATION DESIGN IS NOT RESPONSIBLE FOR ANY WORK COMPLETED WITHOUT INSPECTION OR DEVIATIONS FROM THE DESIGN NOT PREVIOUSLY AUTHORIZED IN WRITING. ANY CHANGED CONDITIONS THAT MAY AFFECT THE WORK SHALL BE IMMEDIATELY BROUGHT TO THE ATTENTION OF THE DESIGN ENGINEER BEFORE PROCEEDING SO APPROPRIATE ADJUSTMENTS CAN BE MADE.
- 17. CONTRACTOR TO PROTECT AND MAINTAIN EXISTING UTILITIES AS PER CIVIL AND STRUCTURAL DRAWINGS. ALL EXISTING UTILITIES MAY NOT BE SHOWN ON SURVEY.
- 18. ALL EXCAVATION SHALL COMPLY WITH OSHA REQUIREMENTS.
- 19. THE CONTRACTOR SHALL PROVIDE POSITIVE PROTECTION (MAT/SHEET COVERINGS) FOR ALL EXCAVATION SLOPES TO PROTECT SLOPES FROM INSTABILITY AND DETERIORATION DUE TO RAIN. WIND OR SNOW.
- 20. CONTRACTOR SHALL OBTAIN ALL REQUIRED WORK PERMITS SUCH AS, BUT NOT LIMITED TO NYCDOT SIDEWALK AND ROAD CLOSURE PERMITS.
- 21. CONTRACTOR SHALL COORDINATE THE PROJECT WITH NYCDOT AND NYSDOT, WORK INVOLVING THE CITY SEWERS AND WATER MAINS WITH NYC DEP, AND ALL WORK INVOLVING ELECTRIC MAINS WITH CON EDISION.
- 22. THE CONTRACTOR SHALL BE RESPONSIBLE FOR MAINTAINING A WORKABLE SURFACE THAT FACILITATES ALL PROJECT OPERATIONS OF THE CONTRACTOR, ENGINEER, AND THE OWNER. WHERE APPLICABLE, A WORKABLE SURFACE IS FURTHER DEFINED IN THE CONTRACT SPECIFICATIONS.
- 23. ANY TRANSPORTER OF CONTAMINATED/HAZARDOUS MATERIAL SHALL BE LICENSED IN THE STATE(S) IN WHICH HANDLING AND TRANSPORTATION SHALL TAKE PLACE, IN ACCORDANCE WITH REGULATIONS.
- 24. THE CONTRACTOR SHALL INSPECT THE SITE ENTRANCES, EXITS, AND ADJOINING ROADWAYS FOR EVIDENCE OF OFF-SITE SOIL TRACKING. EXISTING SITE CONDITIONS SHALL BE MAINTAINED. THE CONTRACTOR SHALL CLEAN EQUIPMENT AND TRUCKS LEAVING THE SITE, AND ADJACENT STREETS AT NO ADDITIONAL COST TO THE OWNER.
- 25. CONTRACTOR MUST MEET MINIMUM CLEARANCE DIMENSIONS PER THE ARCHITECTURAL DRAWINGS. CORRECTIVE ACTION TO PROVIDE MINIMUM CLEARANCE BY CONTRACTOR.
- 26. DO NOT OVER-EXCAVATE UNLESS DIRECTED BY THE OWNER'S ENGINEER FOR REMOVAL OF UNSUITABLE SOIL.
- 27. DO NOT SCALE DRAWINGS FOR DIMENSIONAL INFORMATION.
- 28. SUPPORT OF EXCAVATION DESIGN IS SUBJECT TO REVISIONS PENDING FINAL FOUNDATION DESIGN.
- 29. NO WORK SHALL BE PERFORMED WITHOUT DIRECT ON-SITE SUPERVISION BY THE ENGINEER OR THE OWNER.

#### MONITORING:

- 1. CONTRACTOR SHALL HAVE A NEW YORK STATE LICENSED SURVEYOR ESTABLISH HORIZONTAL AND VERTICAL CONTROL
- 2. SURVEY MONITORING POINTS AND SEISMOGRAPHS SHALL BE INSTALLED AT LOCATIONS IDENTIFIED IN THE PRE-CONSTRUCTION DOCUMENTATION REPORT AND IN CONSULTATION WITH THE OWNER'S ENGINEER AND AGENCIES HAVING JURISDICTION.
- 3. AT A MINIMUM, SURVEY MONITORING POINTS SHALL BE INSTALLED AT THE TOP OF EVERY THIRD CONCRETE PIER. INSTALL SURVEY MONITORING POINTS VERTICALLY IN 15 FOOT MAXIMUM INTERVALS BEGINNING AT THE TOP OF WALL.
- 4. INSTALL SURVEY MONITORING POINTS ON EXISTING BUILDINGS AND SUBSURFACE STRUCTURES, INCLUDING THE NYCT SUBWAY STRUCTURE AT MAXIMUM HORIZONTAL INTERVALS OF 25 FEET, BUT NOT LESS THAN TWO POINTS PER WALL.
- 5. SURVEY MONITORING SHALL BE PERFORMED ON A TWICE WEEKLY BASIS DURING EXCAVATION. MONITORING INTERVALS SHALL BE INCREASED TO DAILY WHERE MOVEMENTS ARE FOUND TO EXCEED THE PRESCRIBED ALERT LEVELS.
- 6. IN THE EVENT THAT MONITORING INDICATES LATERAL MOVEMENT EXCEED THE LIMIT LEVELS DEFINED IN THE SPECIFICATIONS, THE CONTRACTOR SHALL CEASE CONSTRUCTION ACTIVITIES. WHERE REQUIRED, THE CONTRACTOR SHALL PROVIDE STABILIZATION OF THE EXCAVATION SUPPORT SYSTEM VIA INSTALLATION OF TEMPORARY EARTHEN BERMS AND/OR ADDITIONAL BRACING. ADDITIONAL EXCAVATION ACTIVITIES SHALL NOT PROCEED WITHOUT THE AUTHORIZATION OF THE OWNER'S ENGINEER AND ANY

AGENCIES HAVING JURISDICTION.

- 7. ALL SURVEY MONITORING POINTS SHALL BEAR A UNIQUE IDENTIFICATION. AS-BUILT PLANS SHALL BE PREPARED FOR ALL SURVEY MONITORING POINTS INSTALLED. PLANS SHALL BE AMENDED AS REQUIRED DURING CONSTRUCTION FOR THE ABANDONMENT, REPLACEMENT, OR ADDITION OF NEW SURVEY MONITORING LOCATIONS. ALL MONITORING RESULTS SHALL BE PROVIDED TO THE CONSTRUCTION MANAGER AND OWNER'S ENGINEER WITHIN 24 HOURS OF TAKING READINGS.
- 8. THE MAXIMUM PERMISSIBLE VIBRATION LEVEL FOR ALL CONSTRUCTION ACTIVITIES SHALL BE 2.0 INCHES PER SECOND AS MEASURED AT THE NEAREST OCCUPIED BUILDING WALL. THRESHOLD TRIGGER VALUES FOR GEOPHONES SHALL BE SET TO A MAXIMUM OF 0.5 INCHES PER SECOND. THE MAXIMUM PERMISSIBLE LEVELS SHALL BE CALCULATED AS THE PEAK VECTOR SUM OF VELOCITY MEASUREMENTS TAKEN IN THREE ORTHOGONAL DIRECTIONS.
- 9. CONTRACTOR TO PLACE A CONCRETE SLAB FOR EACH OF THE SEISMOGRAPH LOCATIONS SHOWN ALONG THE FOLLOWING BUILDINGS: 1560 BROADWAY AVENUE, 155 WEST 46TH STREET, 151 WEST 46TH STREET, AND 150 WEST 47TH STREET.

#### **UNDERPINNING GENERAL NOTES:**

- 1. THE EXISTING GRADE IN FRONT OF BUILDINGS TO BE UNDERPINNED SHALL NOT BE EXCAVATED ANY WIDER THAN FOUR (4) FEET (THE WIDTH OF ONE UNDERPINNING PIER) PRIOR TO COMPLETING THE UNDERPINNING INSTALLATION, UNLESS APPROVED IN WRITING BY THE ENGINEER. ALL EXCAVATION FOR THE APPROACH PITS AND UNDERPINNING PIERS SHALL BE SHEETED OR SLOPED IN ACCORDANCE WITH OSHA REQUIREMENTS.
- 2. ALL EXCAVATION FOR UNDERPINNING SHALL BE COMPLETED BY HAND IN SHEETED PITS AS SHOWN IN THE DETAILS.
- 3. CONCRETE FOR UNDERPINNING PIERS SHALL HAVE A MINIMUM COMPRESSIVE STRENGTH OF 5,000 PSI AT 28 DAYS.
- 4. TRANSFER OF LOAD SHALL BE ACCOMPLISHED BY THE USE OF STEEL PLATES AND WEDGES NO SOONER THAN 18 HOURS AFTER PLACING CONCRETE FOR THE UNDERPINNING PIERS. A MINIMUM OF

TWO (2) SETS OF STEEL PLATES AND WEDGES SHALL BE

5. DRY-PACK SHALL BE MADE UP OF EQUAL PARTS OF SAND AND CEMENT, WITH SUFFICIENT WATER TO MAKE THE MIXTURE MOIST.

INSTALLED AT EACH UNDERPINNING PIER.

- 6. CONTRACTOR SHALL CONFIRM TRANSFER OF THE BUILDING LOAD ONTO THE UNDERPINNING PIERS USING SURVEY INSTRUMENTS AND/OR "TELL-TALES".
- 7. CONCRETE UNDERPINNING SHOULD BE PERFORMED USING "ALTERNATE PIT" METHOD SUCH THAT ADEQUATE SUPPORT IS MAINTAINED UNDER EXISTING FOUNDATIONS. EXCAVATE AND POUR CONCRETE UNDERPINNING FOR PITS "A". AFTER CONCRETE ATTAINS AT LEAST 75% OF DESIGN COMPRESSIVE STRENGTH PACK 2-INCH DRY-PACK INTO SPACE BETWEEN TOP OF UNDERPINNING AND BOTTOM OF EXISTING FOOTING TO TRANSFER LOAD. REPEAT PROCEDURE FOR PITS "B", "C" AND "D
- 8. UNDERPINNING PIERS SHALL BE CARRIED DOWN TO THE ELEVATIONS SHOWN ON THE CONTRACT DRAWINGS, TO COMPETENT SOIL, OR TO COMPETENT ROCK, WHICHEVER IS DEEPER. IF COMPETENT SOIL OR ROCK IS NOT FOUND AT THE ELEVATION SHOWN ON THE DRAWINGS, THE ENGINEER SHALL REVIEW THE FIELD CONDITIONS AND MAKE NECESSARY RECOMMENDATIONS.
- 9. EACH UNDERPINNING PIER SHALL NOT BE MORE THAN 4'-0" WIDE UNLESS OTHERWISE INDICATED. ALL UNDERPINNING PIERS SHALL BE AT LEAST 3'-0" THICK (I.E. EXTEND 2'-0" BACK UNDER THE EXISTING FOOTING) UNLESS OTHERWISE INDICATED. IF THE WIDTH OF THE EXISTING FOOTING IS GREATER THAN 3'-0", THE UNDERPINNING PIERS SHALL BE AS THICK AS THE FOOTING IS
- 10. UNDERPINNING PIERS SHALL BE INSTALLED WITH ONE 1-FT LIFT.
- 11. UNDERPINNING PIER PITS CLOSER THAN 12 FT O.C. ARE NOT TO BE EXCAVATED AT THE SAME TIME.
- 12. IF THE EXISTING FOUNDATION OBSERVED TO BE IN POOR CONDITION, THE CONTRACTOR SHOULD NOTIFY THE ENGINEER, AND REMOVE OR REPAIR LOOSE/DAMAGED MATERIALS PER DIRECTION OF THE ENGINEER.
- 13. OVER-EXCAVATION FOR INSTALLATION OF SHEETING SHALL NOT BE PERMITTED.
- 14. CONCRETE SHALL BE PLACED THE SAME DAY AS THE PIT IS EXCAVATED UNLESS OTHERWISE APPROVED BY THE ENGINEER.
- 15. THE BOTTOM ELEVATION OF THE EXISTING FOUNDATIONS ARE TAKEN FROM EXISTING FOUNDATIONS DRAWINGS AND ARE TO BE VERIFIED IN THE FIELD WITH TEST PITS.
- 16. CONTRACTOR SHALL VERIFY ALL DIMENSIONS AND CONDITIONS IN
- 17. AT EXISTING BUILDING COLUMNS, NO MORE THAN 1/3 OF THE COLUMN FOOTINGS FOR THE BUILDING SHALL BE UNDERPINNED AT ANY TIME.
- 18. ADDITIONAL TEMPORARY SHORING OF THE COLUMNS MAY BE REQUIRED DURING THE UNDERPINNING PROCESS.
- 19. WHEN THE UNDERPINNING PIER HEIGHT EXCEEDS 10 FT IN HEIGHT. THE UNDERPINNING PIER SHALL BE LATERALLY BRACED.

20. IF REQUIRED, ANCHORS SHALL BE INSTALLED PRIOR TO

EXCAVATING BELOW LEVEL OF ANCHORS, CONTRACTOR MAY

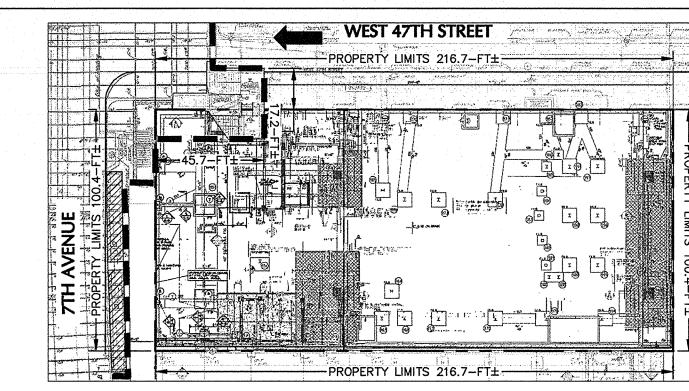
- SUBMIT ALTERNATIVE METHODS OF PROVIDING LATERAL SUPPORTS FOR UNDERPINNING PIERS. 21. UNDERPINNING PIERS SHALL BE SHEETED ON FOUR SIDES WITH
- HORIZONTAL TIMBERS. THESE HORIZONTAL TIMBER BOARDS SHALL BE "LOUVERED". THAT IS, THEY SHALL BE SPACED 1-1/2" TO 2' APART TO PERMIT FILLING AND BACKPACKING OF ANY VOIDS THAT OCCUR BEHIND THE LAGGING. LAGGING SHALL BE BACKPACKED WITH PERMEABLE SOIL TO PREVENT ANY BUILD-UP OF HYDROSTATIC PRESSURE BEHIND SHEETING.
- 22. THE EXTENT OF THE UNDERPINNING IN A HORIZONTAL DIRECTION IS DETERMINED BY A 45 DEGREE INFLUENCE LINE.
- 23. PRIOR TO EXCAVATING ANY UNDERPINNING PIERS, THE CONTRACTOR WILL NEED PERMISSION FROM THE PROPERTY OWNERS OF SAID BUILDINGS TO BE UNDERPINNED.
- 24. ALL UNDERPINNING WORK SHALL BE SUBJECT TO CONTROLLED INSPECTION IN ACCORDANCE WITH CHAPTER 18 SECTION 1814 OF THE NEW YORK CITY BUILDING CODE.
- 25. THE FULL SCOPE OF THIS WORK SHALL BE DETERMINED BY THE CONTRACTOR BY SITE REVIEW PRIOR TO BIDDING.
- 26. ADJACENT UNDERPINNING PITS SHOULD NOT BE EXCAVATED UNTIL LOAD HAS BEEN TRANSFERRED TO THE SUBJECT PIT AND NOT LESS THAN 48 HOURS AFTER CONCRETE PLACEMENT OF THE SUBJECT PIT.
- 27. CONTRACTOR SHALL NOTIFY DOB 24-48 HOURS PRIOR TO COMMENCEMENT OF EXCAVATION
- 28. THE CONTRACTOR SHALL BE RESPONSIBLE FOR THE STRUCTURAL STABILITY OF THE ADJACENT BUILDINGS IN ACCORDANCE WITH CHAPTER 33 SECTION 3309 OF THE NEW YORK CITY BUILDING

#### TIMBER LAGGING INSTALLATION NOTES: (AS REQUIRED)

- 1. LAGGING BOARDS SHALL BE INSTALLED BETWEEN CONCRETE PIER AS THE EXCAVATION PROGRESSES. IN NO CASE SHALL EXCAVATION AT THE REAR FACE OF SOLDIER PILE EXTEND MORE THAN 2 FEET BELOW LAGGED SECTIONS.
- 2. ADJACENT LAGGING BOARDS SHALL BE LOUVERED A DISTANCE OF 2 INCHES TO ALLOW FOR BACKPACKING OF DISTURBED AREAS OR VOIDS. LOUVERING MAY BE CEASED AT THE DISCRETION OF THE INSPECTING GEOTECHNICAL ENGINEER BASED ON CONDITIONS ENCOUNTERED.
- 3. DISTURBED AREAS, VOIDS, AND MATERIAL LOST BEHIND LAGGING SHALL BE BACKPACKED WITH A DRY SOIL/CEMENT MIXTURE. HAY OR FILTER FABRIC SHALL BE USED TO PREVENT MIGRATION OF FINES THROUGH LOUVER OPENINGS.
- 4. BACKFILL SHALL BE PLACED AND COMPACTED AS INDICATED HEREIN, OR AS DIRECTED BY THE INSPECTING GEOTECHNICAL ENGINEER.
- 5. ALTERNATE METHODS OF SUPPORT OF EXCAVATION, WHERE PROPOSED SHALL BE ACCOMPANIED BY ALL SUPPORTING CALCULATIONS

#### DEWATERING NOTES (UNDER SEPARATE APPLICATION, IF REQUIRED):

- 1. ADEQUATE PUMPS, WELL POINTS, OR OTHER EQUIPMENT. APPURTENANCES, POWER, DRAINS, MATERIALS AND LABOR NECESSARY TO DO ALL THE PUMPING AND DEWATERING NEEDED TO KEEP ALL EXCAVATIONS DRY DURING THE CASTING OF PILE CAPS. PIERS. AND FOUNDATION ELEMENTS. AND AT SUCH OTHER TIMES AS THE PROGRESS OF THE WORK MAY DEMAND OR AS NECESSARY TO INSURE SAFETY TO THE STRUCTURE SHALL BE PROVIDED.
- 2. OBTAIN NECESSARY PERMIT FOR DISCHARGING WATER TO THE CITY SEWER. DIRECT DISCHARGE INTO THE EAST RIVER SHALL NOT BE PERMITTED WITHOUT ALL FEDERAL, STATE AND CITY PERMITS.
- 3. ALL PUMPING AND DEWATERING BOTH INSIDE AND OUTSIDE THE AREAS OF THE BUILDING SHALL BE PERFORMED, CONTINUED AND MAINTAINED AS REQUIRED FOR THE COMPLETION OF ALL WORK. INCLUDING THE WORK OF THE MECHANICAL TRADES, THROUGHOUT THE PERIOD OF THE CONTRACT.
- 4. DURING EXCAVATION FOR AND PLACING OF SLABS, WALLS, PILE CAPS, PITS, ETC., THE EXCAVATION SHALL BE KEPT DRY. THE DEWATERING SYSTEM SHALL BE CAPABLE OF MAINTAINING THIS CONDITION UNTIL THE SITE IS BACKFILLED AND THE REMOVAL OF THE DEWATERING SYSTEM WILL NOT ENDANGER ANY CONSTRUCTION AREA. ALL PUMPED WATER SHALL BE REMOVED FROM THE BUILDING AREA.
- 5. THE DEWATERING SYSTEM SHALL MAINTAIN A DRY EXCAVATION WITH A GROUNDWATER LEVEL AT LEAST A MINIMUM 2 FEET BELOW THE LOWEST SUBGRADE ELEVATIONS.
- 6. THE DEWATERING SYSTEM OR SYSTEMS SHALL BE INSTALLED AND OPERATED IN SUCH A MANNER AS TO AVOID THE MOVEMENT OF FINES OR LOSS OF GROUND FROM BELOW THE BEARING LEVEL AND SHALL NOT INFLUENCE THE STABILITY OF SURROUNDING AREAS. THE FACILITIES NEEDED TO ELIMINATE LOSS OF GROUND SHALL BE INCLUDED.
- 7. THE CONTRACTOR SHALL NOT USE ANY PORTION OF THE BUILDING FOUNDATION UNITS OR ANY PART THEREOF AS A SUMP FOR DRAINAGE RESULTING FROM PUMPING IN ANY OTHER AREA. THE CONTRACTOR SHALL NOT CONDUCT WATER TO PRIVATELY OWNED PROPERTIES.



KEY PLAN SCALE: 1" = 40'

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#### Project: 1568 Broadway

Date: No.: Description:

New York, NY 10036

Sheet Title:

**GENERAL NOTES** 

**Project Number** Drawn By: SCS Checked B

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SOE-003.00

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- 2. ALL ROCK EXCAVATION ADJACENT TO THE TRANSIT STRUCTURE IS TO BE CHANNEL DRILLED TWO FEET BELOW
- 3. IF TOP OF ROCK IS FOUND BELOW SUBWAY STRUCTURE, THE SUBWAY STRUCTURE MUST BE UNDERPINNED IN ACCORDANCE WITH DRAWINGS TO BE SUBMITTED TO NYCT FOR APPROVAL.
- 4. IF ROCK IS SOFT OR SEAMY, LATERAL SUPPORTS MUST BE PROVIDED BELOW THE SUBWAY STRUCTURE IN ACCORDANCE WITH DRAWINGS TO BE SUBMITTED TO NYCT FOR APPROVAL.
- 5. BLASTING WILL BE PERMITTED ONLY WITH LIGHT CHARGES SUBJECT TO THE APPROVAL OF NYCT'S ENGINEER AND IN ACCORDANCE WITH THE REGULATIONS OF THE FIRE DEPARTMENT. THE CONTRACTOR SHALL PROVIDE A DETAILED MONITORING PLAN. PROVIDING FOR MEASUREMENTS OF BOTH PARTICLE VELOCITY AND DISPLACEMENTS AT CRITICAL LOCATIONS OF THE NYCT STRUCTURE. THE MONITORING PLAN SHALL INCLUDE THRESHOLD AND UPSET LEVELS OF BOTH PARTICLE VELOCITY AND SETTLEMENT TOGETHER WITH AN ACTION PLAN FOR THEIR IMPLEMENTATION. THE CONTRACTOR SHALL SECURE AN APPROVED SEISMOLOGIST TO INSTALL AND OPERATE SUITABLE VELOCITY GAUGES TO CONTINUOUSLY MONITOR PARTICLE VELOCITY AND AN INDEPENDENT LICENSED SURVEYOR TO MONITOR DISPLACEMENTS. THE PRESENCE OF A QUALIFIED TECHNICIAN FROM MONITORING COMPANY IS NECESSARY TO PROVIDE THE VIBRATION READING UPON REQUEST OF NYCT ENGINEER. THE THRESHOLD MAXIMUM PARTICLE VELOCITY ABOVE AMBIENT CAUSED BY THE BLASTING WILL BE 0.5 INCH PER SECOND. VALUES EXCEEDING THIS LEVEL WILL BE REVIEWED AND EVALUATED BY NYCT'S ENGINEER. IN NO CASE WILL PARTICLE VELOCITIES EXCEED THE UPSET LEVEL OF 2.0 INCHES PER SECOND.
- 6. BEFORE PLACING CONCRETE, THE SUBGRADE OF THE FOUNDATIONS IN THE VICINITY OF THE SUBWAY STRUCTURE IS TO BE INSPECTED AND APPROVED BY NYCT'S ENGINFER.
- 7. IF ANY PORTION OF THE SUBWAY STRUCTURE OR FINISH IS DAMAGED, IT SHALL BE REPAIRED OR REPLACED WITH THE SAME MATERIALS IN PLACE, SUBJECT TO THE APPROVAL OF NYCT'S ENGINEER AND AT THE EXPENSE OF THE PROJECT.
- 8. EXCAVATION EMBANKMENTS ARE TO BE SHORED AND BRACED. DRAWINGS INDICATING A SUGGESTED METHOD OF CONSTRUCTION ARE TO BE SUBMITTED TO NYCT FOR APPROVAL IN CONJUNCTION WITH THE PROJECT'S CONTRACT DRAWINGS. IN CASE OF EXCAVATION UNDERMINING THE SUBWAY STRUCTURE, UNDERPINNING MAY BE REQUIRED. DRAWINGS FOR UNDERPINNING ARE TO BE SUBMITTED TO NYCT FOR APPROVAL.
- TEMPORARY SHORING MAY BE PLACED IN DIRECT CONTACT WITH NYCT STRUCTURES ONLY IF THE NYCT STRUCTURE IS SHOWN TO BE ABLE TO SUPPORT ALL ANTICIPATED LOADS THAT CAN BE TRANSFERRED THROUGH THE TEMPORARY STRUCTURES WITHOUT DAMAGING THE EXISTING STRUCTURE. AT THE COMPLETION OF THE PROJECT, THESE TEMPORARY SHORING AND BRACING SYSTEMS ARE TO BE REMOVED OR CUT-OFF AS APPROVED BY NYCT.
- 10. WHEN PILES ARE TO BE DRIVEN OR DRILLED ADJACENT TO THE SUBWAY STRUCTURE, BORING DATA, PILE LAYOUTS, SPECIFICATIONS AND INSTALLATION PROCEDURES ARE TO BE SUBMITTED TO NYCT FOR APPROVAL. VELOCITY METERS ARE TO BE INSTALLED IN THE SUBWAY TUNNEL AT CRITICAL LOCATIONS TO MONITOR INDUCED VIBRATIONS. INDUCED DISPLACEMENTS ALONG THE TUNNEL STRUCTURE AND TRACK INVERT ARE TO BE MONITORED DURING DRIVING OR DRILLING. THE THRESHOLD MAXIMUM PARTICLE VELOCITY ABOVE AMBIENT CAUSED BY THE DRIVING OR DRILLING WILL BE 0.5 INCH PER SECOND. VALUES EXCEEDING THIS LEVEL WILL BE REVIEWED AND EVALUATED BY NYCT'S ENGINEER. IN NO CASE WILL PARTICLE VELOCITIES EXCEED THE UPSET LEVEL OF 2.0 INCHES PER SECOND.
- 11. NO PILES ARE PERMITTED TO BE INSTALLED BY ANY METHOD WITHIN THREE FEET OF SUBWAY STRUCTURE, MEASURED FROM THE EDGE OF THE PILE OR CASING TO THE WALL. CLOSED-END PILES WILL NOT BE PERMITTED TO BE DRIVEN WITHIN TEN FEET OF THE SUBWAY STRUCTURE.
- 12. ALL PILES ARE TO BE PLACED WITHIN A PREAUGERED CASED HOLE TO THE INFLUENCE LINE. THE CASING SHALL BE CLEANED WITHOUT DISTURBING THE SOIL OUTSIDE THE CASING AND THE PILE TO BE PLACED WITHIN THE CASING FOR INSTALLATION. THE PILES MAY THEN BE DRIVEN BEYOND THE INFLUENCE LINE WITHIN THE
- 13. THE INFLUENCE LINE SHALL START AT THE BOTTOM OF THE SUBWAY STRUCTURE AND EXTEND FROM 1H:1V TO 2H:1V SLOPE DEPENDING ON THE SOIL PROPERTIES AND GROUND WATER TABLE. FOR PILES INSTALLED WITHIN TEN FEET OF THE SUBWAY STRUCTURE, THE CASING SHALL BE EXTENDED UP TO THE BOTTOM OF THE
- 14. ALL PILES ARE TO BE DRIVEN OR DRILLED A MINIMUM OF TEN FEET BELOW THE INTERSECTION OF THE PILE CENTERLINE AND THE INFLUENCE LINE OF THE SUBWAY STRUCTURE.
- 15. THE USE OF 'DOWN-THE-HOLE -HAMMERS" FOR INSTALLATION OF PILES THROUGH OVERBURDEN AND FILL WILL BE PERMITTED ONLY TO REMOVE BOULDERS. IT WILL NOT BE PERMITTED AS A MATTER OF COURSE TO ADVANCE THE HOLE. THEIR USE TO CONSTRUCT ROCK SOCKETS WILL NOT BE ALLOWED WITHIN 5 FEET OF THE NYCT STRUCTURE. THE USE OF MACHINE UTILIZING AIR FOR SOIL REMOVAL WILL NOT BE ALLOWED.
- 16. VIBRATORY HAMMERS WILL NOT BE PERMITTED WITHIN 75 FEET OF SUBWAY STRUCTURES. HOERAMS WILL NOT BE PERMITTED WITHIN 25 FEET OF SUBWAY STRUCTURES.
- 17. DYNAMIC COMPACTION METHODS USING DROPPED HEAVY WEIGHTS CANNOT BE CONDUCTED WITHIN 1000 FEET OF ANY NYCT STRUCTURE UNLESS IT IS SHOWN THAT INDUCED SETTLEMENTS AND VIBRATIONS WILL NOT DAMAGE THESE STRUCTURES. A SUITABLE MONITORING PLAN INCLUDING SETTLEMENT AND VIBRATION MEASUREMENTS MUST BE APPROVED BY NYCT'S ENGINEER FOR ALL SUCH OPERATIONS WITHIN THESE DISTANCES.
- 18. THERE SHALL BE NO MACHINE EXCAVATION WITHIN 3 FEET OF NYCT STRUCTURES, POWER DUCT LINES, OR ANY OTHER FACILITIES UNTIL THEY HAVE BEEN CAREFULLY EXPOSED BY HAND EXCAVATION.
- 19. ALL DEWATERING OPERATIONS CONDUCTED WITHIN 500 FEET OF THE NYCT STRUCTURE MUST BE PERFORMED IN ACCORDANCE WITH DRAWINGS AND PROCEDURES SUBMITTED TO NYCT FOR APPROVAL. THE DISTANCE FROM THE STRUCTURE TO THE DEWATERING OPERATION CAN BE REDUCED PROVIDED THAT SOIL CONDITIONS AT THE SITE INDICATE THAT THE RADIUS OF INFLUENCE OF THE DEWATERING IS LESS THAN 500 FEET. FOR DEWATERING WITHIN THE RADIUS OF INFLUENCE, THE DEWATERING PROGRAM MUST BE SHOWN TO HAVE NEGLIGIBLE INFLUENCE ON SETTLEMENTS OF THE NYCT STRUCTURE.
- 20. SUBWAY ENTRANCES (VENTILATORS, ETC.) ARE TO BE UNDERPINNED OR SHORED AND BRACED IF DIRECTED BY NYCT'S ENGINEER.
- 21. NYCT, AT ITS DISCRETION, RESERVES THE RIGHT TO REQUIRE THE PROJECT TO CLOSE OR MAINTAIN AND PROTECT EXISTING SUBWAY ENTRANCES, VENTILATORS, ETC. ADJACENT TO THE PROJECT DURING CONSTRUCTION. SUCH CONSTRUCTION MAY INCLUDE UNDERPINNING, SHORING, BRACING AND ERECTION OF SUITABLE BARRICADES AND/OR CANOPIES AND SHIELDS. SUCH PROTECTION SHALL BE IN ACCORDANCE WITH DRAWINGS SUBMITTED TO NYCT FOR APPROVAL.
- 22. IF SHIELDS ARE TO BE INSTALLED TO PROTECT NYCT FACILITIES AND/OR THE PUBLIC, PLANS SHOWING THE LOCATION. TYPE AND METHOD OF ATTACHMENT TO THE TRANSIT STRUCTURE MUST BE SUBMITTED TO NYCT FOR APPROVAL.
- 23. ALL LUMBER AND PLYWOOD USED FOR PROTECTION OF SUBWAY FACILITIES MUST BE FIRE RETARDANT. 24. SUBWAY EMERGENCY EXITS MUST BE KEPT CLEAR AT ALL TIMES.
- 25. IN EXCAVATING OVER OR NEAR THE SUBWAY ROOF, SPECIAL CARE SHALL BE EXERCISED SO THAT THE THIN

CONCRETE PROTECTION OF THE SUBWAY WATERPROOFING IS NOT DAMAGED.

- 26. BURNING OF, WELDING TO OR DRILLING THROUGH EXISTING STEEL STRUCTURES WILL NOT BE PERMITTED
- EXCEPT AS SHOWN ON DRAWINGS APPROVED BY NYCT. 27. HORIZONTAL AND VERTICAL CONTROL SURVEY DATA OF THE EXISTING NYCT STRUCTURE IS TO BE TAKEN BY A

LICENSED LAND SURVEYOR TO MONITOR ANY MOVEMENTS THAT OCCUR DURING CONSTRUCTION AND TO SHOW THAT THE INDUCED MOVEMENTS ARE WITHIN ALLOWABLES NOTED BELOW. IF ANY MOVEMENTS EXCEED ALLOWABLES, REMEDIATION AS APPROVED BY NYCT SHALL BE PERFORMED.

> ELEVATED SUBWAY

NOTIFY NYCT ENGINEER 1/8 INCH 1/4 INCH

STOP WORK 1/4 INCH 1/2 INCH

28. BUS ROUTES AFFECTED BY THE PROJECT WILL OR MAY REQUIRE BUS DIVERSIONS. THESE ARRANGEMENTS SHALL BE MADE THROUGH:

> MS. SARAH WYSS ACTING DIRECTOR, OPERATIONS PLANNING NEW YORK CITY TRANSIT 2 BROADWAY, ROOM A17.82 NEW YORK, NEW YORK 10004 TELEPHONE NUMBER 646/252-5517

WHEN IMPACTING ANY BUS STOP, SPECIAL OPERATIONS MUST BE NOTIFIED TWO WEEKS IN ADVANCE

29. DUCT LINES MUST BE MAINTAINED AND PROTECTED DURING CONSTRUCTION. ANY INTERFERENCE WITH DUCT LINES SHOULD BE REPORTED TO NYCT INSPECTOR. WHEN A DUCT LINE CONTAINING CABLES IS TO BE REMOVED, OR WHEN MASONRY ADJACENT THERETO IS TO BE REMOVED, PENETRATED, OR DRILLED, THE WORK SHALL BE DONE WITH HAND LABOR ENTIRELY, USING HAMMER AND CHISEL. JACKHAMMERS, BULL POINTS OR OTHER POWER EQUIPMENT SHALL NOT BE USED.

30. WHERE MANHOLES ARE ENCOUNTERED:

a) THEY SHALL BE PROTECTED AND RAISED OR LOWERED AS REQUIRED, TO MATCH THE NEW STREET GRADE.

b) IF MANHOLE COVERS ARE RAISED OR LOWERED, PROTECT CABLES IN MANHOLE BY WOOD SHEETING OF 2"

c) PRIOR TO THE START OF CONSTRUCTION OPERATIONS AFFÉCTING MANHOLES AND DUCT LINES, SEVEN DAYS NOTICE MUST BE GIVEN TO MR. JOHN MALVASIO, P.E., ASSISTANT CHIEF ENGINEERING OFFICER, MAINTENANCE OF WAY, AT 718/694-1358.

31. CONSTRUCTION WORK DONE NEAR VENT GRATINGS AND HATCHES SHALL BE AS FOLLOWS:

- a) UNLESS APPROVED BY THE NYCT'S ENGINEER, ALL VENT GRATINGS AND HATCHES SHOULD REMAIN OUTSIDE THE CONSTRUCTION SITE, SEPARATED BY A CONSTRUCTION FENCE. PROTECTIVE SHIELDS MUST BE PROVIDED OVER VENT GRATINGS AS REQUIRED BY NYCT'S ENGINEER.
- b) NO BUILDING MATERIAL, VEHICLES OR CONSTRUCTION EQUIPMENT IS TO BE STORED OR RUN OVER VENT, GRATINGS, HATCHES OR EMERGENCY EXITS.
- c) DETAILS OF SIDEWALK RECONSTRUCTION AROUND VENT GRATINGS, HATCHES AND EMERGENCY EXITS ARE TO BE SUBMITTED TO NYCT FOR APPROVAL.
- 32. TRACTORS, CRANES, EXCAVATORS, ETC. USED IN THE VICINITY OF THE ELEVATED STRUCTURES SHALL BE ISOLATED FROM THE GROUND. SINCE THE ELEVATED STRUCTURE IS USED AS A NEGATIVE RETURN PATH. WITH A CONSEQUENT POTENTIAL BETWEEN IT AND THE GROUND, ANY CONTACT BETWEEN THE STRUCTURE AND GROUNDED EQUIPMENT COULD RESULT IN BURNING OF THE STEEL.
- 33. TEMPORARY CONSTRUCTION SHEDS, BARRICADES OR PLYWOOD PARTITIONS MUST BE A MINIMUM OF 5'-0" FROM EDGE OF FINISHED PLATFORM.
- 34. STATION AREAS OR STAIRWAY/CLOSINGS: THE GENERAL REQUIREMENTS FOR STATION AREAS OR STAIRWAY/CLOSINGS ARE AS FOLLOWS:
- a) ONLY ONE STAIRWAY AT EACH STATION WILL BE PERMITTED TO BE CLOSED AT THE SAME TIME. APPROVALS FOR CLOSING ANY STAIRWAY MUST BE OBTAINED FROM THE DIVISION OF STATION OPERATIONS AT LEAST THREE WEEKS IN ADVANCE.
- b) MS. SUSANNAH HARRINGTON, DIRECTOR, OFFICE OF STATION PROGRAMS; TELEPHONE 718-243-4891/1695 OF THE DIVISION OF STATIONS MUST BE NOTIFIED ONE WEEK PRIOR TO THE ACTUAL CLOSING AND REOPENING OF THE ENTRANCE.
- c) SIGNAGE MUST BE SUPPLIED AND POSTED AT LEAST ONE WEEK IN ADVANCE, ADVISING THE PUBLIC OF THE PROPOSED SUBWAY STAIR CLOSING. HOWEVER, IF IT IS AN ENTIRE ENTRANCE CLOSING, SIGNAGE MUST BE POSTED TWO WEEKS IN ADVANCE.
- d) THE STREET ENTRANCE STAIRWAY SHOULD NOT BE CLOSED UNLESS MANPOWER AND MATERIALS ARE AVAILABLE TO COMMENCE WORK ON DATES PERMITTED.
- e) ONCE THE CLOSING IS EFFECTED, CONSTRUCTION SIGNS MUST BE PLACED AT APPROPRIATE LOCATIONS ON THE BARRICADES AT THE STREET AND MEZZANINE LEVELS, STATING THE CONTRACTOR'S NAME, 24 HOUR EMERGENCY TELEPHONE NUMBER, CONTRACT NUMBER, THE DURATION OF THE CLOSING, DIRECTION TO AN ALTERNATE ENTRANCE/EXIT, AND AN APOLOGY FOR THE INCONVENIENCE TO OUR CUSTOMERS
- f) EXISTING STATION SIGNAGE MUST BE ADJUSTED TO REFLECT ANY CHANGES IN ACCESS/EGRESS.
- a) BARRICADES ARE TO BE PAINTED AND KEPT GRAFFITI FREE AT ALL TIMES. THE CONTRACTOR MUST MAINTAIN THE BARRICADED AREA CLEAN OF ALL DEBRIS.
- h) ALL MATERIALS ARE TO BE PROPERLY STORED AND SECURED AWAY FROM PASSENGER TRAFFIC.
- i) THE CONTRACTOR MUST REMOVE ALL WASTE MATERIAL AND BARRICADES FROM ALL STATION AREAS WHEN CONSTRUCTION IS COMPLETED.
- i) INSPECTION OF THE AREA UNDER CONSTRUCTION BY AUTHORIZED STATION DEPARTMENT EMPLOYEES SHALL
- k) IF STREETLIGHTS ON THE SIDEWALKS ARE AFFECTED, TEMPORARY LIGHTS SHALL BE PROVIDED.
- 35. IF NEW CONCRETE CONSTRUCTION IS JOINED TO EXISTING CONCRETE, DOWELS AND KEYWAYS ARE TO BE USED IN ACCORDANCE WITH NYCT STANDARDS.
- 36. IF THE PROJECT INVOLVES CONSTRUCTION OR ALTERATION OF A SUBWAY FACILITY ON PRIVATE PROPERTY, THE PROPERTY OWNERS WILL BE REQUIRED TO ENTER INTO AN AGREEMENT WITH NYCT PERTAINING TO ALL WORK AFFECTING THE TRANSIT FACILITIES AND CLEARLY DEFINING LIMITS AND RESPONSIBILITY FOR MAINTENANCE AND
- 37. WHEREVER A NEW SIDEWALK IS BEING PLACED ADJACENT TO NYCT STRUCTURES THE FOLLOWING WILL BE REQUIRED:
- a) THE TOP OF THE NEW SIDEWALK SHALL BE FLUSH WITH THE SUBWAY VENT GRATINGS, HATCHES AND EMERGENCY EXITS.
- b) THE SLOPE OF THE NEW SIDEWALK SHALL BE SUCH THAT THE DRAINAGE BE AWAY FROM THESE
- c) A 1/2" PREMOLDED FILLER SHALL BE INSTALLED BETWEEN THE NEW SIDEWALK AND NYCT STRUCTURE.
- d) WHERE SIDEWALK ELEVATIONS ARE BEING CHANGED DETAILS OF PROPOSED WORK AROUND NYCT STRUCTURES ARE TO BE SUBMITTED FOR APPROVAL.
- 38. BEFORE ENTERING NYCT PROPERTY. CONTRACTOR OR SUBCONTRACTOR'S PERSONNEL SHALL HAVE ATTENDED NYCT TRACK SAFETY TRAINING AND EXPECT TO FOLLOW NYCT RULES AND REGULATIONS AS PER TRAINING AND ENGINEER INSTRUCTIONS
- 39. BEFORE THE START OF ANY WORK, THE CONTRACTOR SHALL MAKE AN EXAMINATION, IN THE PRESENCE OF NYCT'S ENGINEER, OF THE INTERIOR AND EXTERIOR OF NYCT SUBWAY OR OTHER STRUCTURE ADJACENT TO THE PROPOSED WORK. THE PERSON OR PERSONS AUTHORIZED BY THE CONTRACTOR TO MAKE THESE EXAMINATIONS SHALL BE APPROVED BY THE ENGINEER. THE CONTRACTOR SHALL TAKE ALL PHOTOGRAPHS AS MAY BE NECESSARY OR ORDERED TO INDICATE THE EXISTING CONDITION OF NYCT STRUCTURE. ONE COPY OF EACH PHOTOGRAPH, EIGHT INCHES BY TEN INCHES IN SIZE, AND THE NEGATIVE IS TO BE SUBMITTED TO MR. JOHN MALVASIO, P.E., ASSISTANT CHIEF ENGINEERING OFFICER, MAINTENANCE-OF-WAY, 130 LIVINGSTON STREET, ROOM 8044D, BROOKLYN, NEW YORK 11201, TELEPHONE 718/694-1358 BEFORE THE START OF CONSTRUCTION.
- 40. ALL ARCHITECTURAL DETAILS (TOKEN BOOTHS, RAILINGS, DOORS, ETC.) ARE TO CONFORM TO THE LATEST NYCT STANDARDS. THESE STANDARDS ARE AVAILABLE AT NYCT.
- 41. STANDARD NYCT INSURANCE CLAUSES ARE TO BE MADE PART OF THE PROJECT'S CONTRACT DRAWINGS. PROOF THAT THE NECESSARY INSURANCE IS IN EFFECT WILL BE REQUIRED BEFORE WORK CAN COMMENCE.
- 42. AT THE CLOSE OF ANY PROJECT INVOLVING CONSTRUCTION OR ALTERATIONS TO TRANSIT FACILITIES. ONE SET OF VELLUMS OR MYLARS, FIVE SETS OF 35MM MICROFILM, AND ELECTRONIC COPIES COMPLYING TO MICROSTATION.DGN FORMAT OF "APPROVED AS-BUILTS" MUST BE PROVIDED TO NYCT FOR ITS RECORDS. FOR DETAILS OF SPECIFIC REQUIREMENTS CONTACT NYCT OUTSIDE PROJECTS.
- 43. AT LEAST SEVEN WORKING DAYS PRIOR TO THE START OF CONSTRUCTION OPERATIONS, NOTIFICATION MUST BE GIVEN TO MR. JOHN MALVASIO, P.E., ASSISTANT CHIEF ENGINEERING OFFICER, MAINTENANCE-OF-WAY, AT 718/694-1358. THE CONTRACTOR TO PROVIDE TEMPORARY QUARTERS NEAR THE JOB SITE FOR NYCT INSPECTORS CONTAINING A DESK AND TELEPHONE

#### NYCT "NOT FOR BENEFIT" INSURANCE REQUIREMENTS

SECTION A: INSURANCE REQUIREMENTS

THE PERMITTEE AT ITS SOLE COST AND EXPENSE SHALL CARRY AND MAINTAIN POLICIES OF INSURANCE AT ALL TIMES DURING THE PERIOD OF PERFORMANCE UNDER THIS AGREEMENT AS HEREIN SET FORTH BELOW:

- 1. WORKERS' COMPENSATION: INCLUDING EMPLOYER'S LIABILITY INSURANCE WITH LIMITS OF LIABILITY NOT LESS THAN \$2,000,000 WHICH MAY BE MET BY A COMBINATION OF PRIMARY AND EXCESS INSURANCE MEETING THE STATUTORY LIMITS OF NEW YORK STATE.
- 2. COMMERCIAL GENERAL LIABILITY: (ISO 2001 FORM OR EQUIVALENT) APPROVED BY PERMITTOR IN THE PERMITTEE'S NAME WITH LIMITS OF LIABILITY IN THE AMOUNT OF NOT LESS THAN \$3,000,000 FOR EACH OCCURRENCE ON A COMBINED SINGLE LIMIT BASIS FOR INJURIES TO PERSONS (INCLUDING DEATH) AND DAMAGE TO PROPERTY, \$3,000,000 GENERAL AGGREGATE AND \$3,000,000 IN THE AGGREGATE WITH RESPECT TO PRODUCTS/COMPLETED OPERATIONS. THE LIMITS MAY BE PROVIDED IN THE FORM OF A PRIMARY POLICY OR COMBINATION OF PRIMARY AND UMBRELLA/EXCESS POLICY. WHEN THE MINIMUM CONTRACT AMOUNTS CAN ONLY BE MET WHEN APPLYING THE UMBRELLA/EXCESS POLICY, THE UMBRELLA/EXCESS POLICY MUST FOLLOW FORM OF THE UNDERLYING POLICY AND BE EXTENDED TO "DROP DOWN" TO BECOME PRIMARY IN THE EVENT PRIMARY LIMITS ARE REDUCED OR AGGREGATE LIMITS ARE EXHAUSTED. SUCH INSURANCE SHALL BE PRIMARY AND NON-CONTRIBUTORY TO ANY OTHER VALID AND COLLECTIBLE INSURANCE AND MUST BE EXHAUSTED BEFORE IMPLICATING ANY PERMITTOR/MTA POLICY AVAILABLE

SUCH POLICY SHOULD BE WRITTEN ON AN OCCURRENCE FORM. AND SHALL INCLUDE THE FOLLOWING

- ADDITIONAL INSURED ENDORSEMENT (I.S.O. FORM CG 20 26 07/04) VERSION OR EQUIVALENT APPROVED BY THE PERMITTOR, SHALL NAME THE INDEMNITEES AS REFERENCED UNDER SECTION B OF THIS AGREEMENT AS
- ADDITIONAL INSUREDS. CONTRACTUAL LIABILITY ASSUMED BY THE PERMITTEE UNDER THIS AGREEMENT.
- PERSONAL AND ADVERTISING INJURY: PRODUCTS—COMPLETED OPERATIONS;
- INDEPENDENT CONTRACTORS; • "XCU" (EXPLOSION, COLLAPSE, AND UNDERGROUND HAZARDS) WHERE NECESSARY;
- CONTRACTUAL LIABILITY EXCLUSION, APPLICABLE TO CONSTRUCTION OR DEMOLITION OPERATIONS TO BE PERFORMED WITHIN 50 FEET OF RAILROAD TRACKS, MUST BE REMOVED, WHERE NECESSARY:
- 3. BUSINESS AUTOMOBILE LIABILITY: (ISO FORM CA 00 01 10 01 OR EQUIVALENT) APPROVED BY THE PERMITTOR IS REQUIRED IF PERMITTEE'S VEHICLE ENTERS PERMITTOR'S PROPERTY. THE INSURANCE MUST BE IN THE NAME OF THE PERMITTEE OR ITS CONTRACTOR ENTERING THE PERMITTOR PROPERTY WITH LIMITS OF LIABILITY IN THE AMOUNT OF NOT LESS THAN \$2,000,000 EACH ACCIDENT FOR CLAIMS FOR BODILY INJURIES (INCLUDING DEATH) TO PERSONS AND FOR DAMAGE TO PROPERTY ARISING OUT OF THE OWNERSHIP. MAINTENANCE OR USE OF ANY OWNED, HIRED OR NON-OWNED MOTOR VEHICLE.
- 4. RAILROAD PROTECTIVE LIABILITY: (ISO-RIMA OR EQUIVALENT FORM) APPROVED BY PERMITTOR COVERING THE WORK TO BE PERFORMED AT THE DESIGNATED JOB SITE AND AFFORDING PROTECTION FOR DAMAGES. ARISING OUT OF BODILY INJURY OR DEATH, PHYSICAL DAMAGE TO OR DESTRUCTION OF PROPERTY. INCLUDING DAMAGE TO THE INSURED'S OWN PROPERTY AND CONFORMING TO THE FOLLOWING:
- THE POLICY SHALL BE ISSUED TO THE "NAMED INSUREDS" LISTED UNDER SECTION B. • THE LIMIT OF LIABILITY SHALL BE NOT LESS THAN \$2,000,000 PER OCCURRENCE, SUBJECT TO A
- \$6,000,000 ANNUAL AGGREGATE: • POLICY MUST BE ENDORSED TO PROVIDE COVERAGE FOR CLAIMS ARISING FROM INJURY TO EMPLOYEES COVERED BY FEDERAL EMPLOYER'S LIABILITY ACT (FELA). • INDICATE THE NAME AND ADDRESS OF THE DESIGNATED CONTRACTOR, PROJECT LOCATION AND DESCRIPTION
- OF WORK, AND PERMIT NUMBER IF APPLICABLE. • EVIDENCE OF RAILROAD PROTECTIVE LIABILITY INSURANCE, MUST BE PROVIDED IN THE FORM OF A POLICY. A DETAILED INSURANCE BINDER (ACORD OR MANUSCRIPT FORM) WILL BE ACCEPTED PENDING ISSUANCE OF THE POLICY, WHICH MUST BE PROVIDED WITHIN 30 DAYS FROM THE EFFECTIVE DATE.
- 5. ENVIRONMENTAL INSURANCE: IN THE EVENT ENVIRONMENTAL OR POLLUTION EXPOSURES EXIST. THE PERMITTEE SHALL REQUIRE THE ENVIRONMENTAL CONTRACTOR OR SUB-CONTRACTOR TO PROVIDE THE APPLICABLE INSURANCE COVERING SUCH EXPOSURE. THE LIMITS AND TYPES OF INSURANCE PROVIDED MUST BE SATISFACTORY TO THE PERMITTOR AND APPROVED PRIOR TO THE START OF THE WORK.

SECTION B: INDEMNITEES (ADDITIONAL INSUREDS / NAMED INSUREDS)

NEW YORK CITY TRANSIT AUTHORITY ("NYCT"), THE MANHATTAN AND BRONX SURFACE TRANSIT OPERATING AUTHORITY ("MABSTOA"), THE STATEN ISLAND RAPID TRANSIT OPERATING AUTHORITY ("SIRTOA"), THE METROPOLITAN TRANSPORTATION AUTHORITY ("MTA") INCLUDING ITS SUBSIDIARIES AND AFFILIATES, MTA CAPITAL CONSTRUCTION ("MTACC"). MTA BUS COMPANY ("MTA BUS"), AND THE CITY OF NEW YORK ("CITY" AS OWNER) AND THE RESPECTIVE AFFILIATES AND SUBSIDIARIES EXISTING CURRENTLY OR IN THE FUTURE OF AND SUCCESSORS TO EACH INDEMNIFIED PARTIES LISTED HEREIN.

SECTION C: GENERAL INSURANCE REQUIREMENTS

- 1. INSURANCE COMPANIES: ALL OF THE INSURANCE REQUIRED BY THIS ARTICLE SHALL BE WITH COMPANIES LICENSED OR AUTHORIZED TO DO BUSINESS IN THE STATE OF NEW YORK WITH AN A.M. BEST COMPANY RATING OF NOT LESS THAN A-/VII OR BETTER AND REASONABLY APPROVED BY THE PERMITTOR/MTA.
- 2. FORMS: ALL FORMS SHALL COMPLY WITH THE INSURANCE SERVICES OFFICE, INC. ("ISO") OR ITS EQUIVALENT APPROVED BY THE INSURANCE DEPARTMENT OF THE STATE OF NEW YORK
- 3. POLICY DEDUCTIBLE / SELF INSURED RETENTION: INSURANCE MAY CONTAIN A DEDUCTIBLE AND OR SELF-INSURED RETENTION AND SHALL NOT EXCEED \$100,000. THE PERMITTEE SHALL BE RESPONSIBLE FOR ALL CLAIM EXPENSES AND LOSS PAYMENTS WITHIN THE DEDUCTIBLE OR SELF-INSURED RETENTION.
- 4. POLICY TERMS: THESE POLICIES MUST: (I) BE WRITTEN IN ACCORDANCE WITH THE REQUIREMENTS OF THE PARAGRAPHS ABOVE. AS APPLICABLE: (II) BE ENDORSED IN FORM ACCEPTABLE TO INCLUDE A PROVISION THAT SHOULD THE POLICY BE CANCELED, MATERIALLY CHANGED, OR NOT RENEWED, NOTICE SHALL BE DELIVERED IN ACCORDANCE WITH THE INSURANCE POLICY PROVISIONS TO THE PERMITTOR, AND (III) STATE OR BE ENDORSED TO PROVIDE THAT THE COVERAGE AFFORDED UNDER THE PERMITTEE'S POLICIES SHALL APPLY ON A PRIMARY AND NOT ON AN EXCESS OR CONTRIBUTING BASIS WITH ANY POLICIES WHICH MAY BE AVAILABLE TO THE PERMITTOR/MTA, AND ALSO THAT THE PERMITTEE'S POLICIES, PRIMARY AND EXCESS MUST BE EXHAUSTED BEFORE IMPLICATING ANY PERMITTOR/MTA POLICY AVAILABLE. (IV) IN ADDITION, PERMITTEE'S POLICIES SHALL STATE OR BE ENDORSED TO PROVIDE THAT, IF A SUBCONTRACTOR'S POLICY CONTAINS ANY PROVISION THAT MAY ADVERSELY AFFECT WHETHER PERMITTEE'S POLICIES ARE PRIMARY AND MUST BE EXHAUSTED BEFORE IMPLICATING ANY PERMITTOR/MTA POLICY AVAILABLE. PERMITTEE'S AND SUBCONTRACTOR'S POLICIES SHALL NEVERTHELESS BE PRIMARY AND MUST BE EXHAUSTED BEFORE IMPLICATING ANY PERMITTOR/MTA POLICY AVAILABLE. AT LEAST TWO (2) WEEKS PRIOR TO THE EXPIRATION OF THE POLICIES. THE PERMITTEE SHALL ENDEAVOR TO PROVIDE EVIDENCE OF RENEWAL OR REPLACEMENT POLICIES OF INSURANCE, WITH TERMS AND LIMITS NO LESS FAVORABLE THAN THE EXPIRING POLICIES.

#### SECTION D: SUBMISSION OF INSURANCE

CERTIFICATES OF INSURANCE MAY BE SUPPLIED AS EVIDENCE OF POLICIES EXCEPT FOR RAILROAD PROTECTIVE LIABILITY. HOWEVER, IF REQUESTED BY THE PERMITTOR, THE PERMITTEE SHALL DELIVER TO THE PERMITTOR WITHIN FORTY-FIVE (45) DAYS A COPY OF SUCH POLICIES, CERTIFIED BY THE INSURANCE CARRIER AS BEING TRUE AND COMPLETE. IF A CERTIFICATE OF INSURANCE IS SUBMITTED, IT MUST: (1) BE PROVIDED ON THE PERMITTOR CERTIFICATE OF INSURANCE; (2) BE SIGNED BY AN AUTHORIZED REPRESENTATIVE OF THE INSURANCE CARRIER OR PRODUCER AND NOTARIZED; (3) DISCLOSE ANY DEDUCTIBLE, SELF-INSURED RETENTION, SUB-LIMIT, AGGREGATE LIMIT OR ANY EXCLUSIONS TO THE POLICY THAT MATERIALLY CHANGE THE COVERAGE; (4) INDICATE THE ADDITIONAL INSUREDS AS REQUIRED HEREIN UNDER SECTION B; THE PERMITTEE MUST PROVIDE A COPY OF THE ADDITIONAL INSURED ENDORSEMENT (ISO) FORM CG 20 26 07/04 OR ITS EQUIVALENT AND MUST REFERENCE THE POLICY INFORMATION: (5) INDICATE PROJECT NAME AND LOCATION ON THE CERTIFICATE: AND (6) EXPRESSLY REFERENCE THE INCLUSION OF ALL REQUIRED ENDORSEMENTS.

THE PERMITTEE OR ITS CONTRACTOR/SUBCONTRACTOR PERFORMING THE WORK SHALL FURNISH EVIDENCE OF ALL POLICIES BEFORE ANY WORK IS STARTED TO THE APPROPRIATE DEPARTMENT:

**NEW AGREEMENTS:** MTA/NYCT MOW ENGINEERING ATTENTION: MR. JOHN MALVASIO 130 LIVINGSTON STREET

BROOKLYN, NY 11201

RENEWAL INSURANCE: MTA RISK INSURANCE MANAGEMENT ATTENTION: RUTH APOSTOL 2 BROADWAY - 21ST FLOOR NEW YORK, NY 10004

SECTION E: NO LIMIT OF LIABILITY THE MINIMUM AMOUNTS OF INSURANCE REQUIRED IN THE DETAIL DESCRIPTION OF POLICIES ABOVE SHALL NOT BE CONSTRUED TO LIMIT THE EXTENT OF THE PERMITTEE'S LIABILITY UNDER THIS AGREEMENT.

SECTION F: RIGHT TO REQUEST ADDITIONAL INSURANCE

PERMITTEE FURTHER AGREES TO PROVIDE, AT PERMITTEE'S SOLE COST AND EXPENSE, SUCH INCREASED OR EXPANDED INSURANCE COVERAGE AS PERMITTOR MAY FROM TIME TO TIME AS DEEM APPROPRIATE.

IF, AT ANY TIME DURING THE PERIOD OF THIS AGREEMENT, INSURANCE AS REQUIRED IS NOT IN EFFECT, OR PROOF THEREOF IS NOT PROVIDED TO THE PERMITTOR, THE PERMITTOR SHALL HAVE THE OPTIONS TO: (I) DIRECT THE PERMITTEE TO SUSPEND WORK OR OPERATION WITH NO ADDITIONAL COST OR EXTENSION OF TIME DUE ON ACCOUNT THEREOF; OR (II) TREAT SUCH FAILURE AS AN EVENT OF DEFAULT.

SECTION H: NOTICE OF CLAIM

SECTION G: EVENT OF DEFAULT

THE PERMITTEE SHALL IMMEDIATELY FILE WITH NYCT/MTA'S TORT DIVISION (WITH A COPY TO THE PROJECT MANAGER), 130 LIVINGSTON STREET, 11TH FLOOR, BROOKLYN, NEW YORK 11201, A NOTICE OF ANY OCCURRENCE LIKELY TO RESULT IN A CLAIM AGAINST NYCT/MTA AND SHALL ALSO FILE WITH THE TORTS DIVISION DETAILED SWORN PROOF OF INTEREST AND LOSS WITH THE CLAIM. THIS PARAGRAPH SHALL SURVIVE THE EXPIRATION OR EARLIER TERMINATION OF THE CONTRACT.

WEST 47TH STREET PROPERTY LIMITS 216.7-FT±

KEY PLAN SCALE: 1" = 40'

PROPERTY LIMITS 216.7-FT±-

# PBDW ARCHITECTS

Platt Byard Dovell White Architects LLP 49 West 37th Street, New York, NY 10018 212.691.2440 | pbdw.com

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212.986.3700 | severud.com

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Urban Foundation Engineering Foundation Engineer 3233 111th Street Flushing, NY 11369 718.478.3021

zeroLUX| Lighting Design 242 West 30th Street, Level 2 New York, NY 10001 212.209.1536

DOB APPROVAL STAMP

04.13.2017 14 IN ACCORDANCE WITH NYCTA COMMENTS 03.13.2017 13 IN ACCORDANCE WITH NYCTA COMMENTS 02.28.2017 12 ISSUED FOR 50% CDs 02.24.2017 11 IN ACCORDANCE WITH NYCTA COMMENT 11.10.2016 10 NYCTA SUBMISSION 10.28.2016 9 100% DESIGN DEVELOPMENT 09.02.2016 8 100% DESIGN DEVELOPMENT 07.15.2016 7 50% DESIGN DEVELOPMENT 06.24.2016 6 TA FILING 05.18.2016 5 DEVELOPMENT REPORT 04.08.2016 4 100% SCHEMATIC DESIGN 02.17.2016 3 50% SCHEMATIC DESIGN 12.24.2015 2 DEVELOPMENT REPORT 12.11.2015 1 FEASIBILITY STUDY

## 1568 Broadway

Date: No.: Description:

New York, NY 10036

**NEW YORK CITY** TRANSIT AUTHORITY **NOTES** 

Project Number: Signature & Seal: 13649 Drawn By: SCS Checked By

Sheet Number:

SOE-004.00

PHASE-3: EXCAVATION AND BRACING OF CAISSONS WHILE EXCAVATION

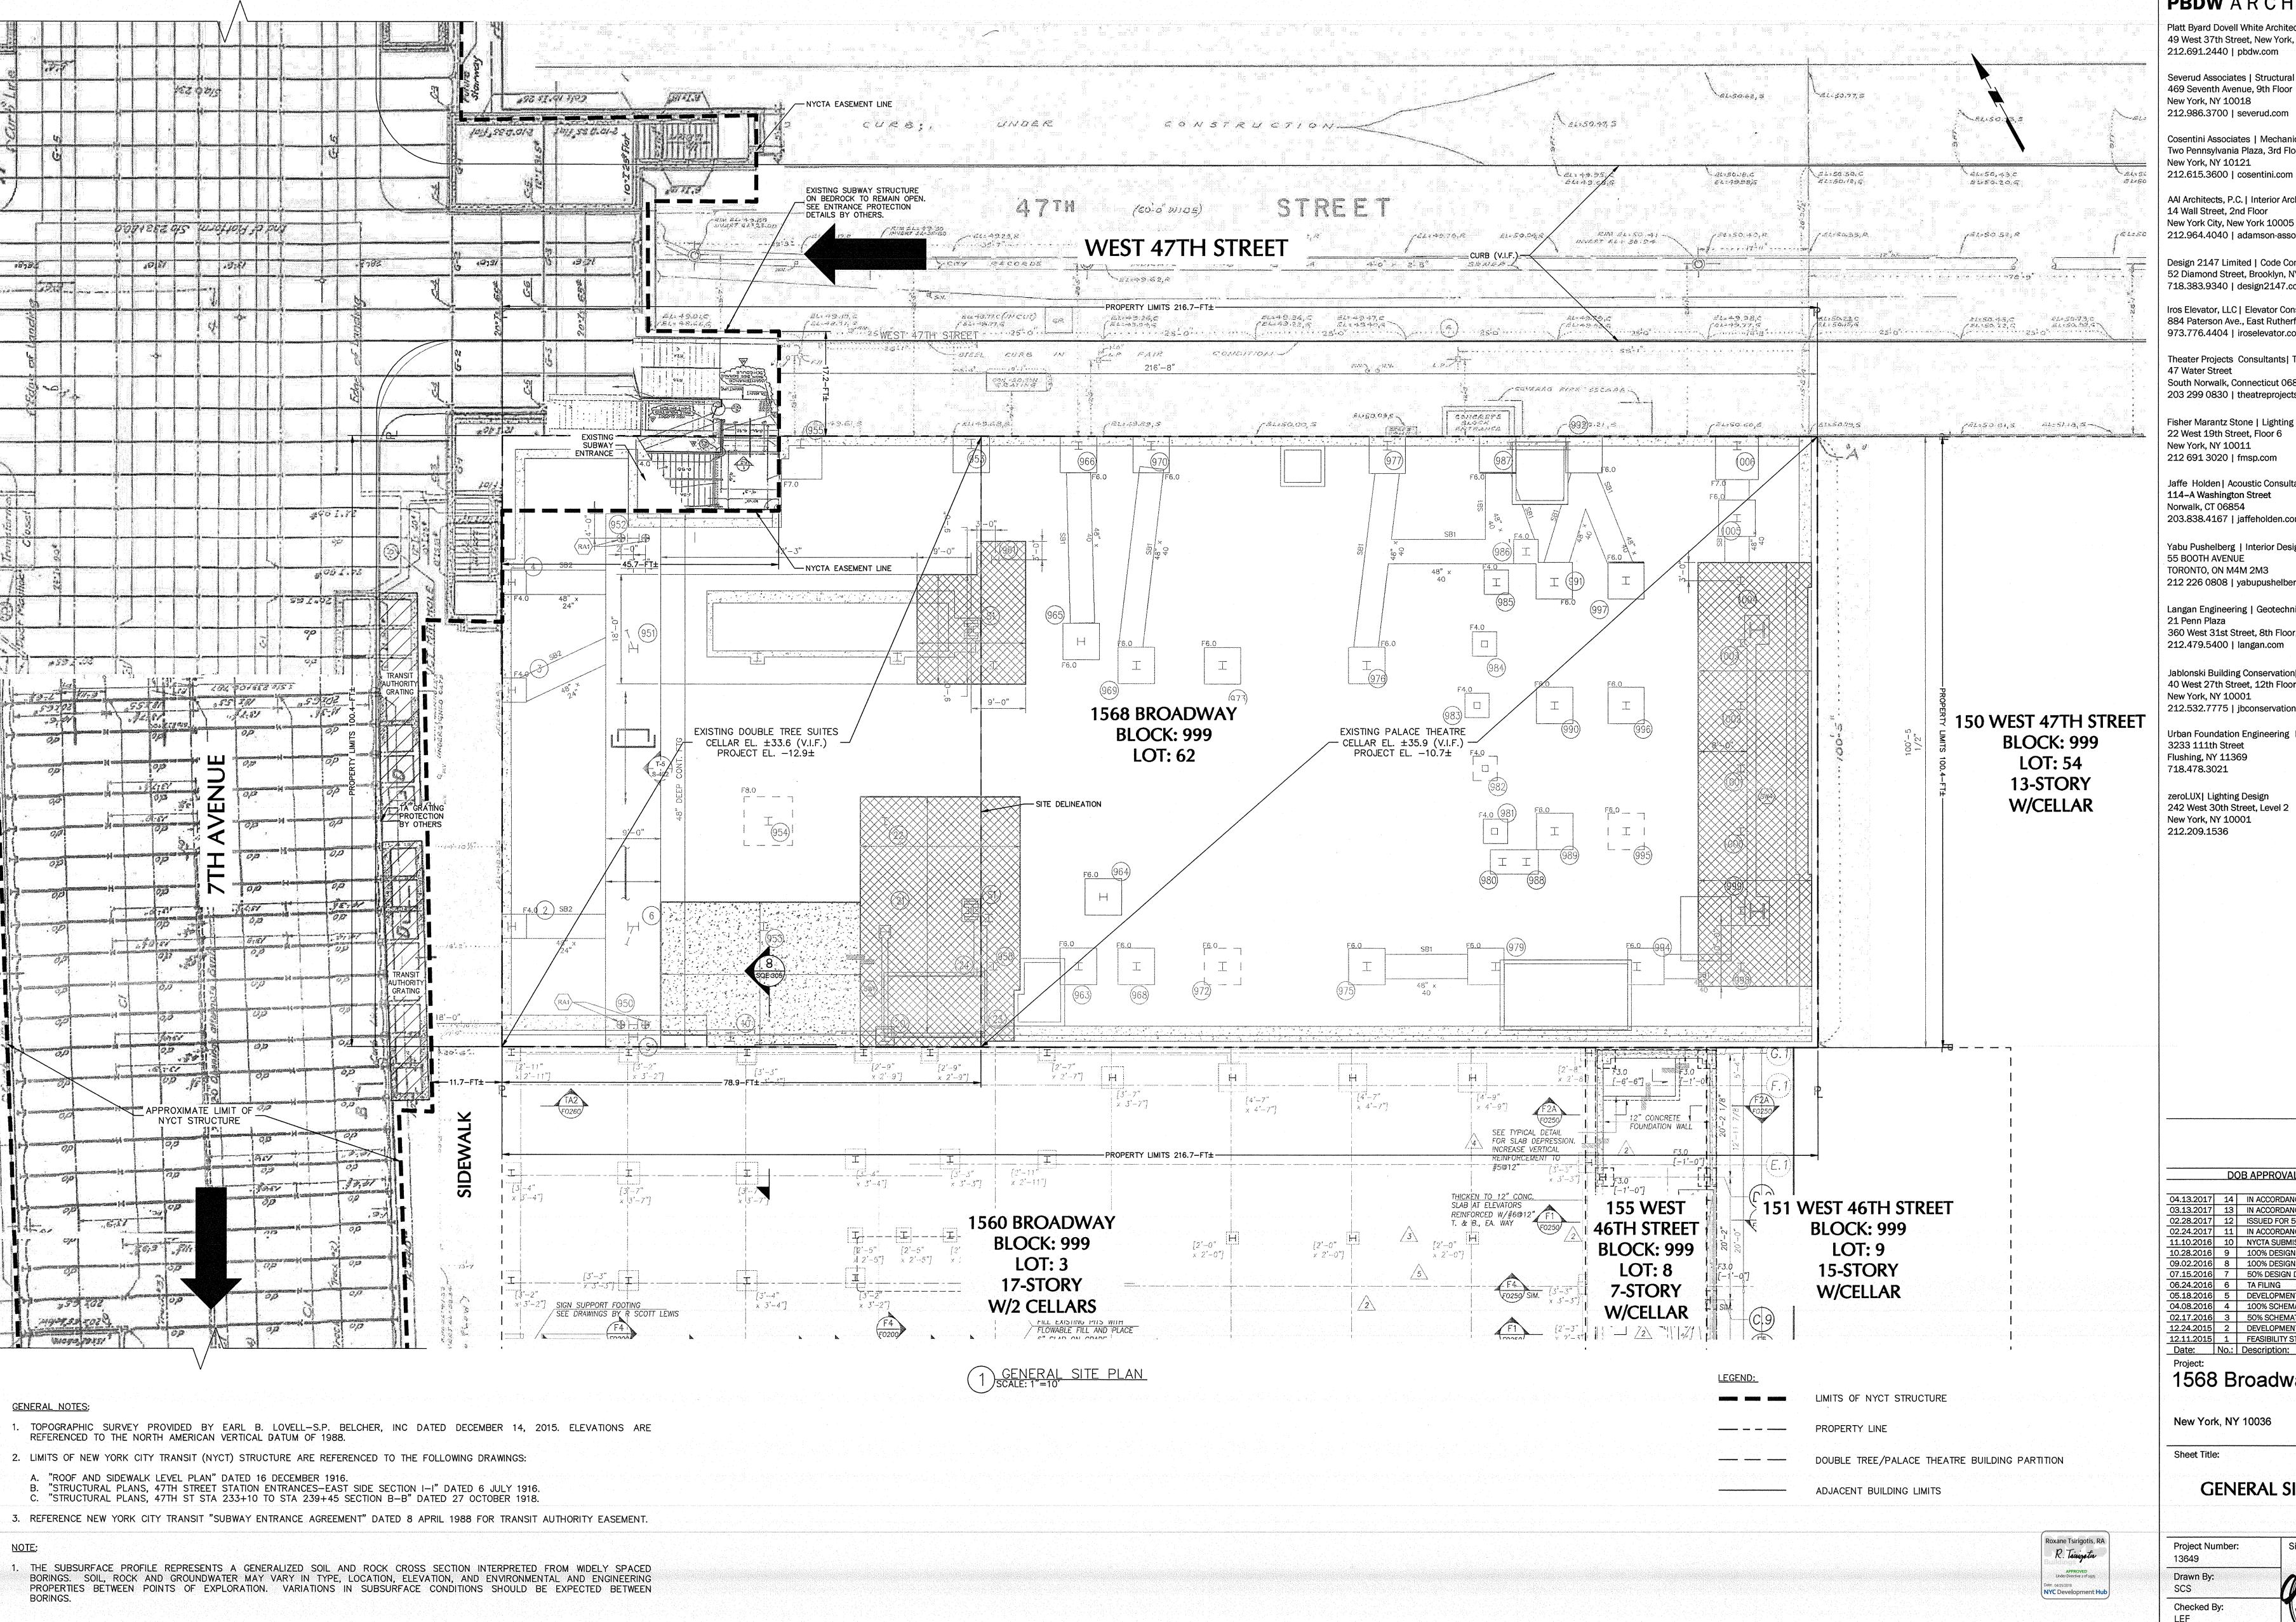
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New York, NY 10036

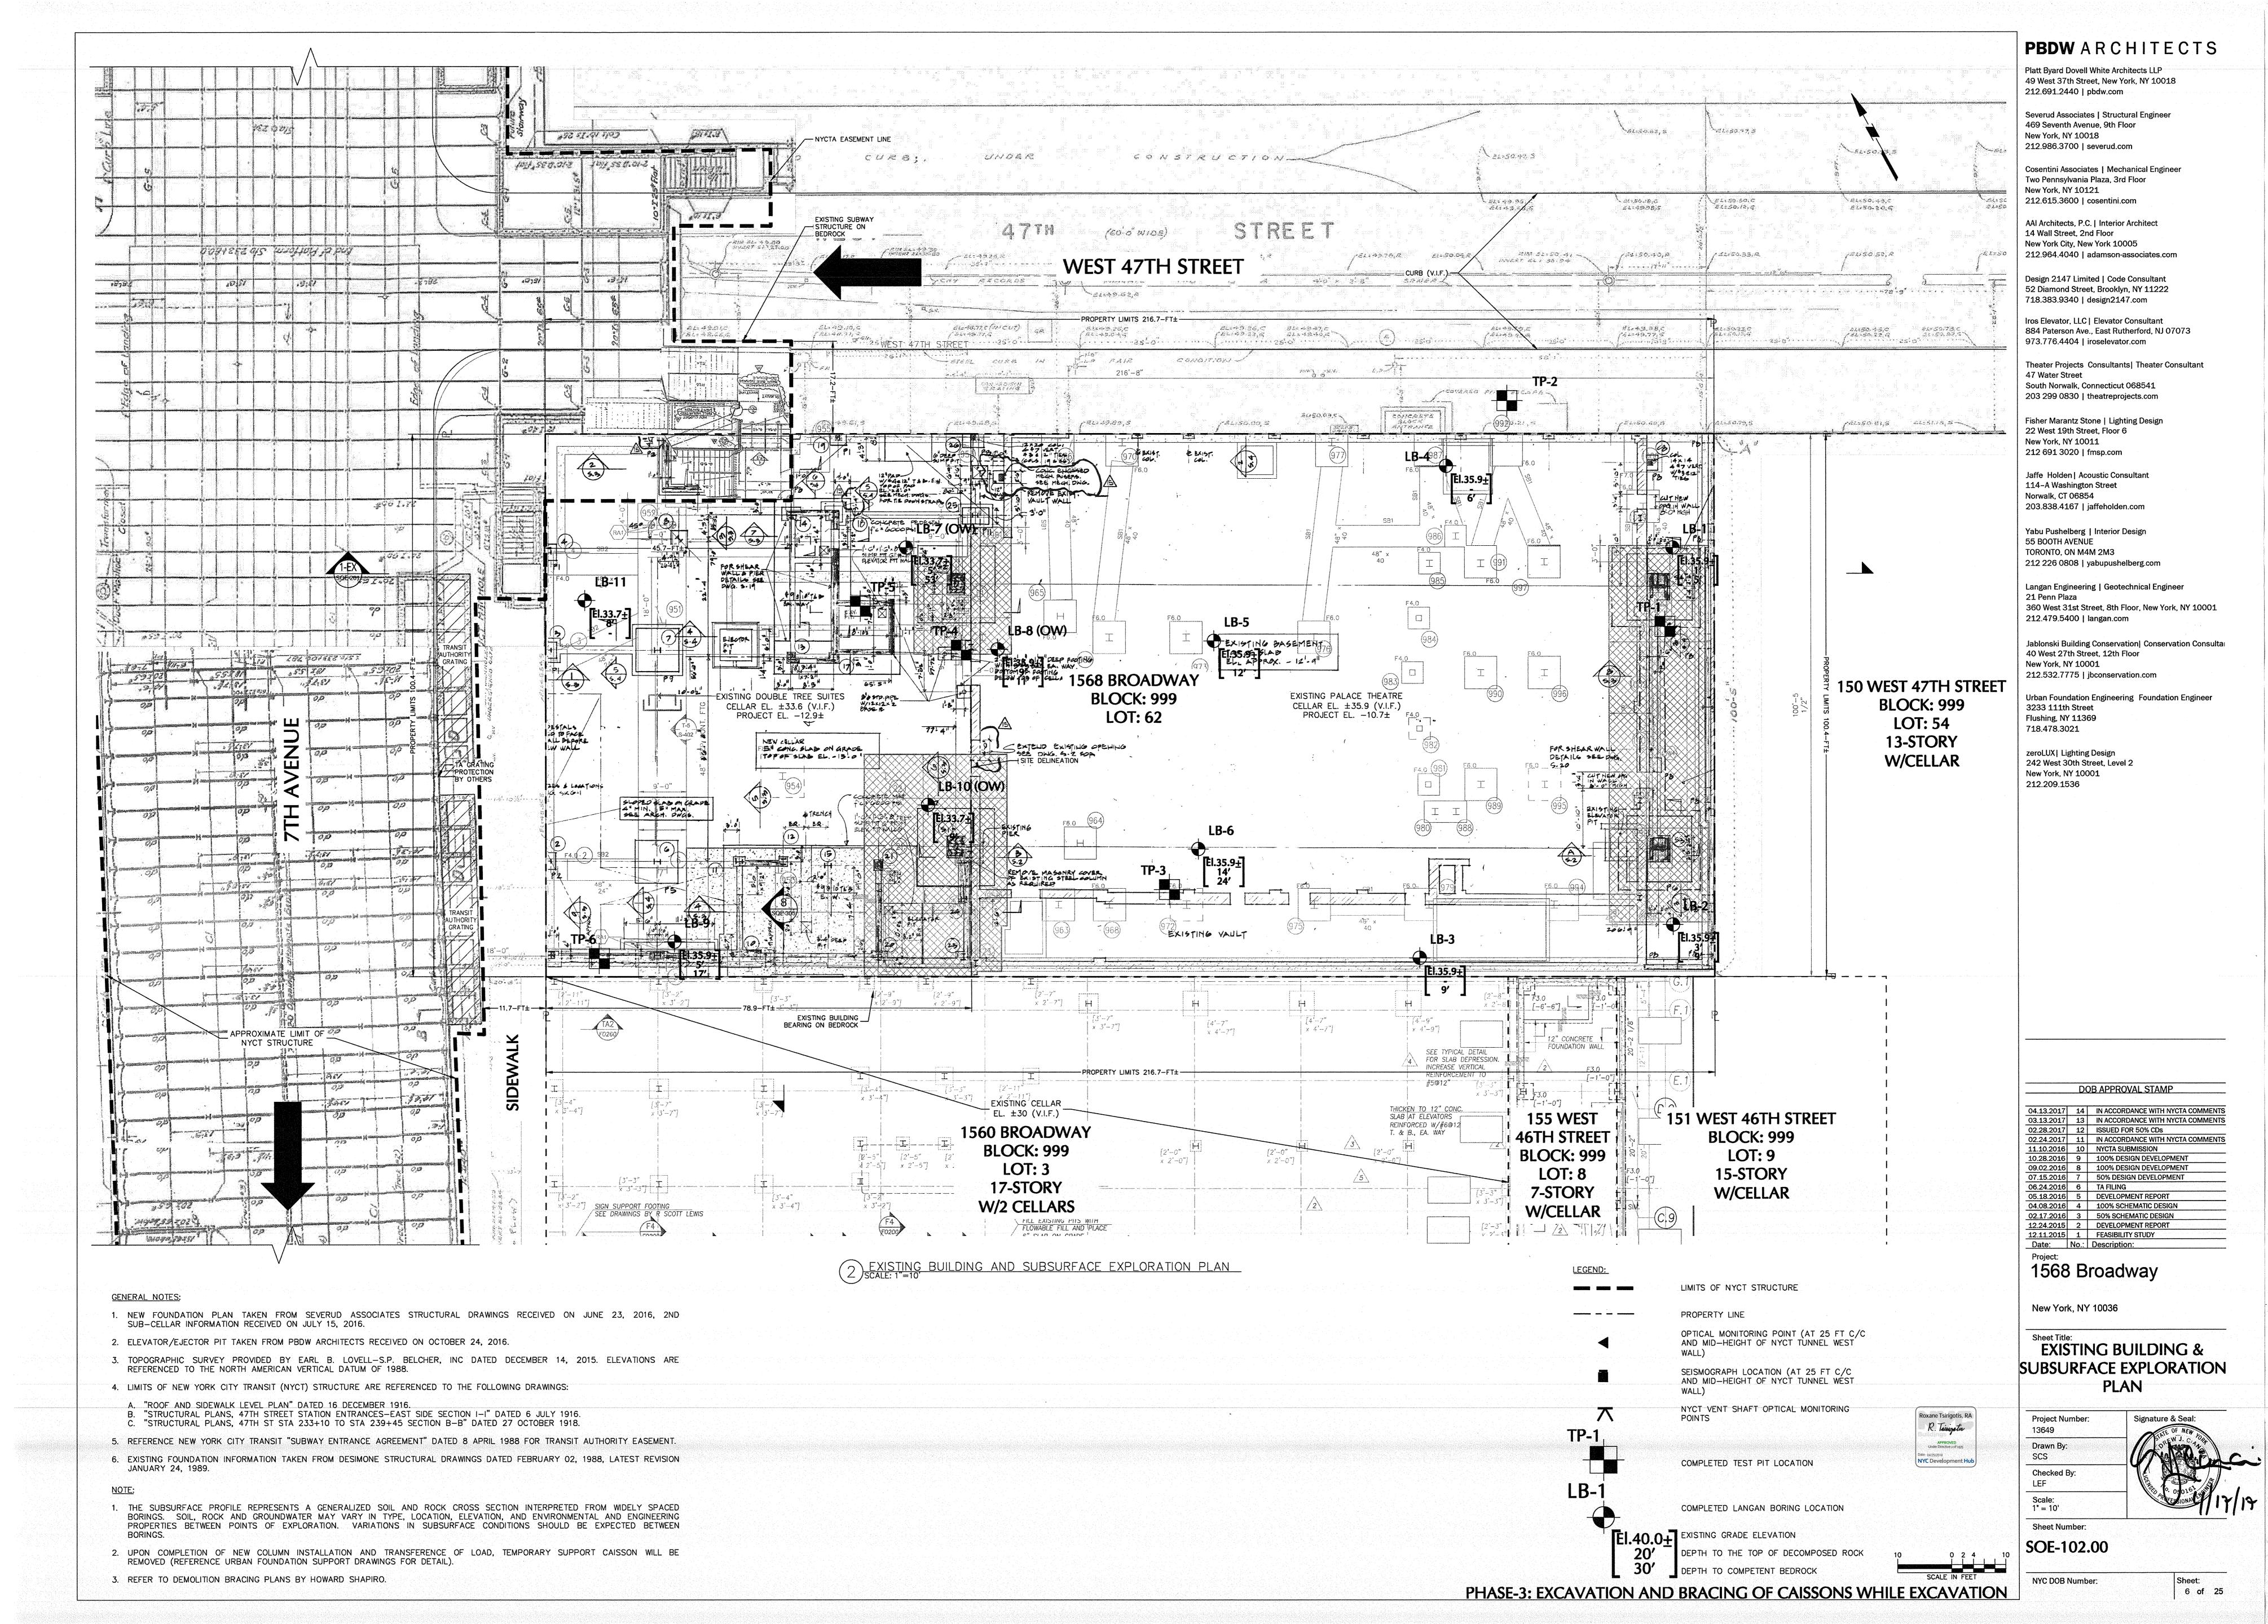
**GENERAL SITE PLAN** 

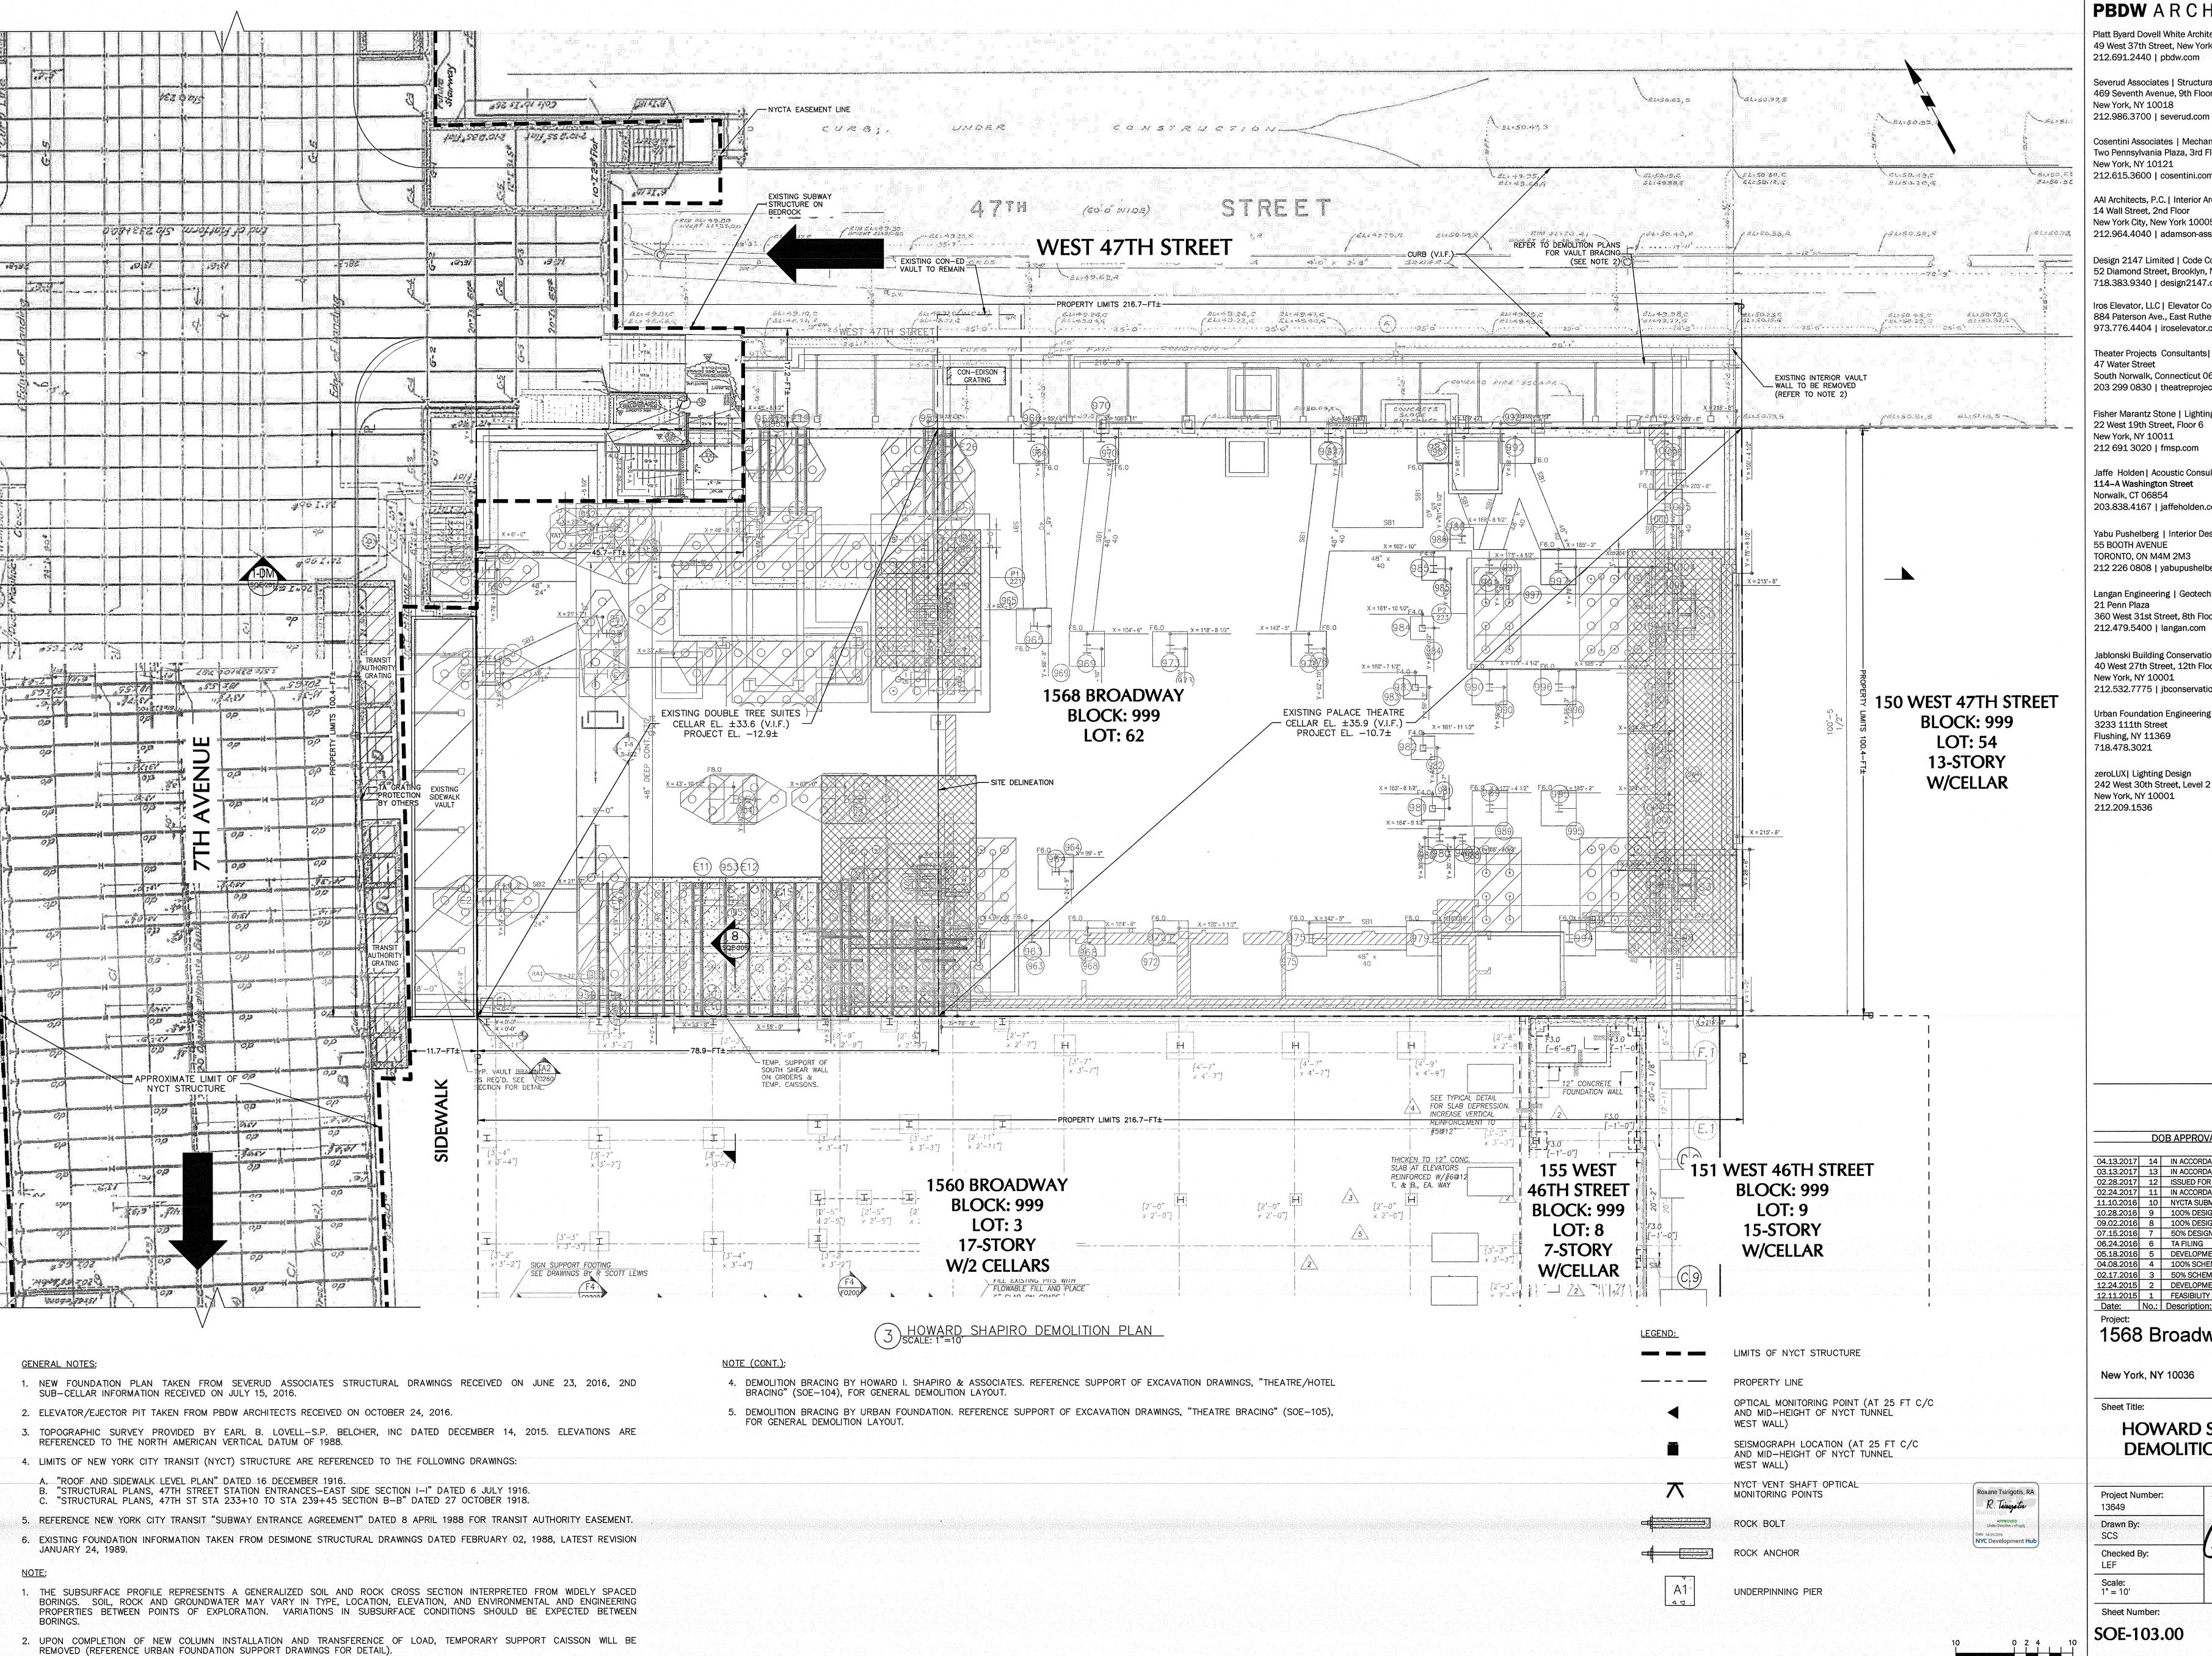
Project Number: Signature & Seal: 13649

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Sheet Number:

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12.11.2015 1 FEASIBILITY STUDY 1568 Broadway

12.24.2015 2 DEVELOPMENT REPOR

New York, NY 10036

HOWARD SHAPIRO **DEMOLITION PLAN** 

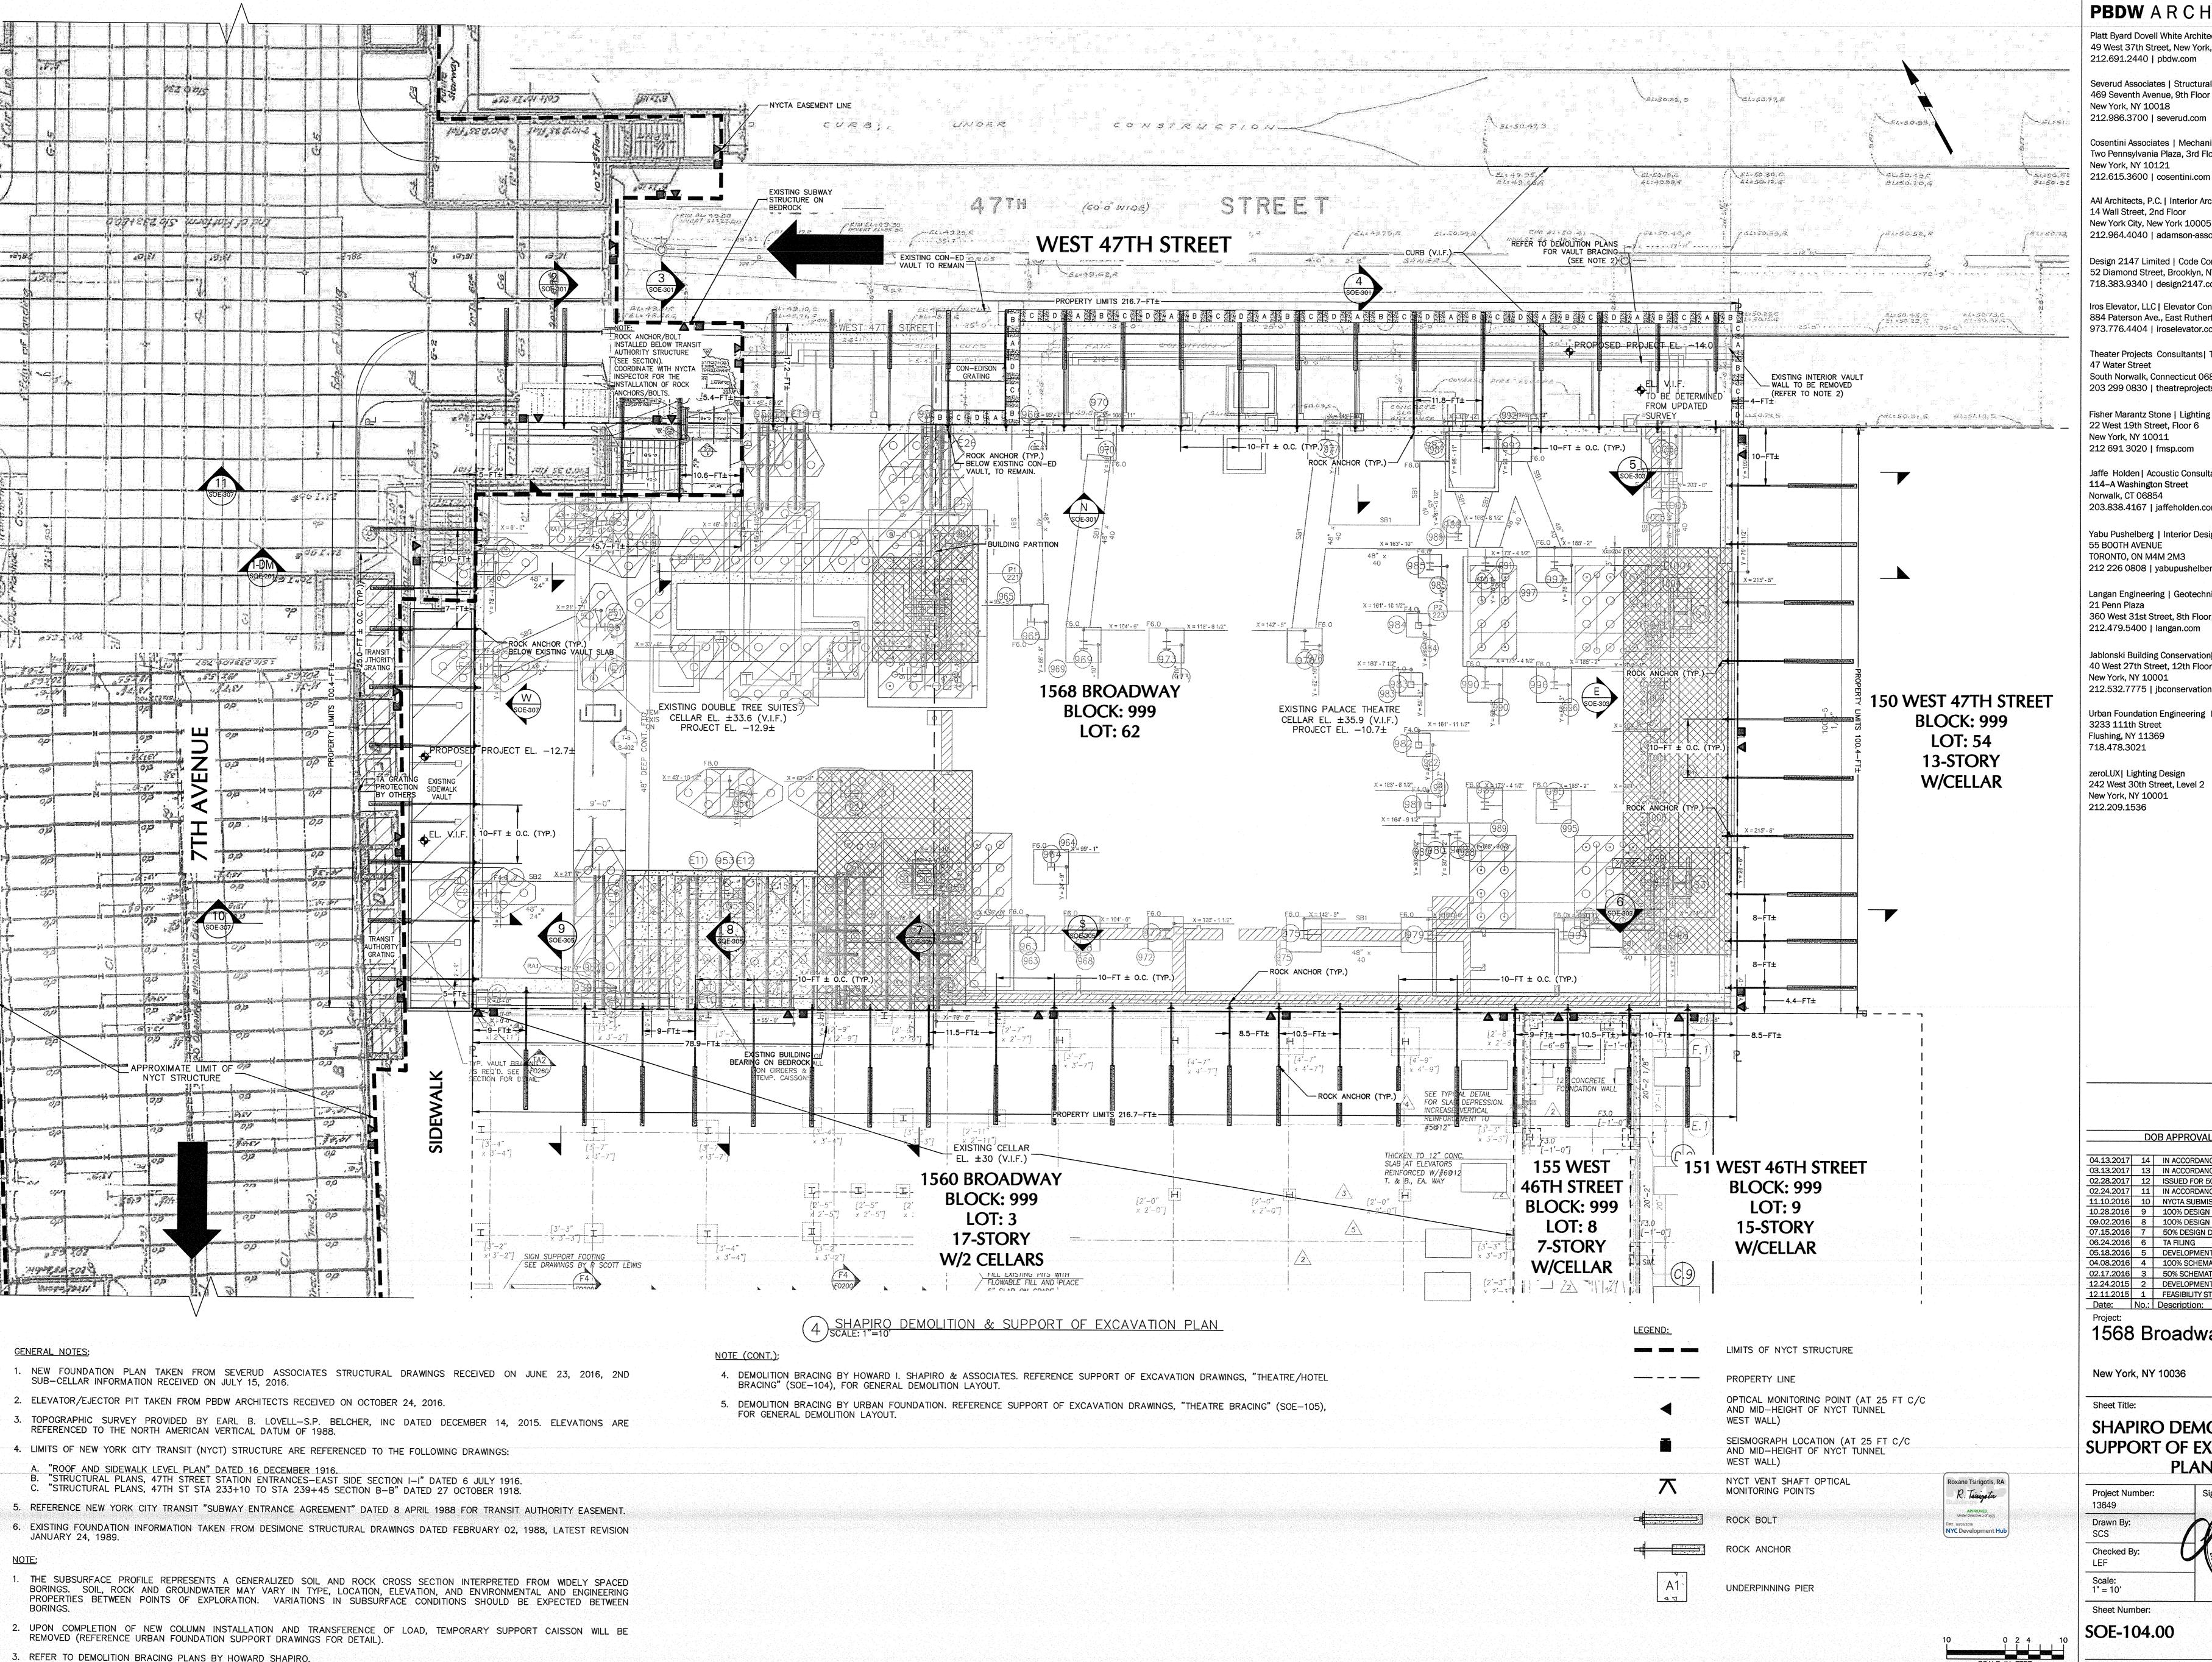
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**Project Number:** Signature & Seal: 13649

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1568 Broadway

New York, NY 10036

**SHAPIRO DEMOLITION &** SUPPORT OF EXCAVATION

PLAN

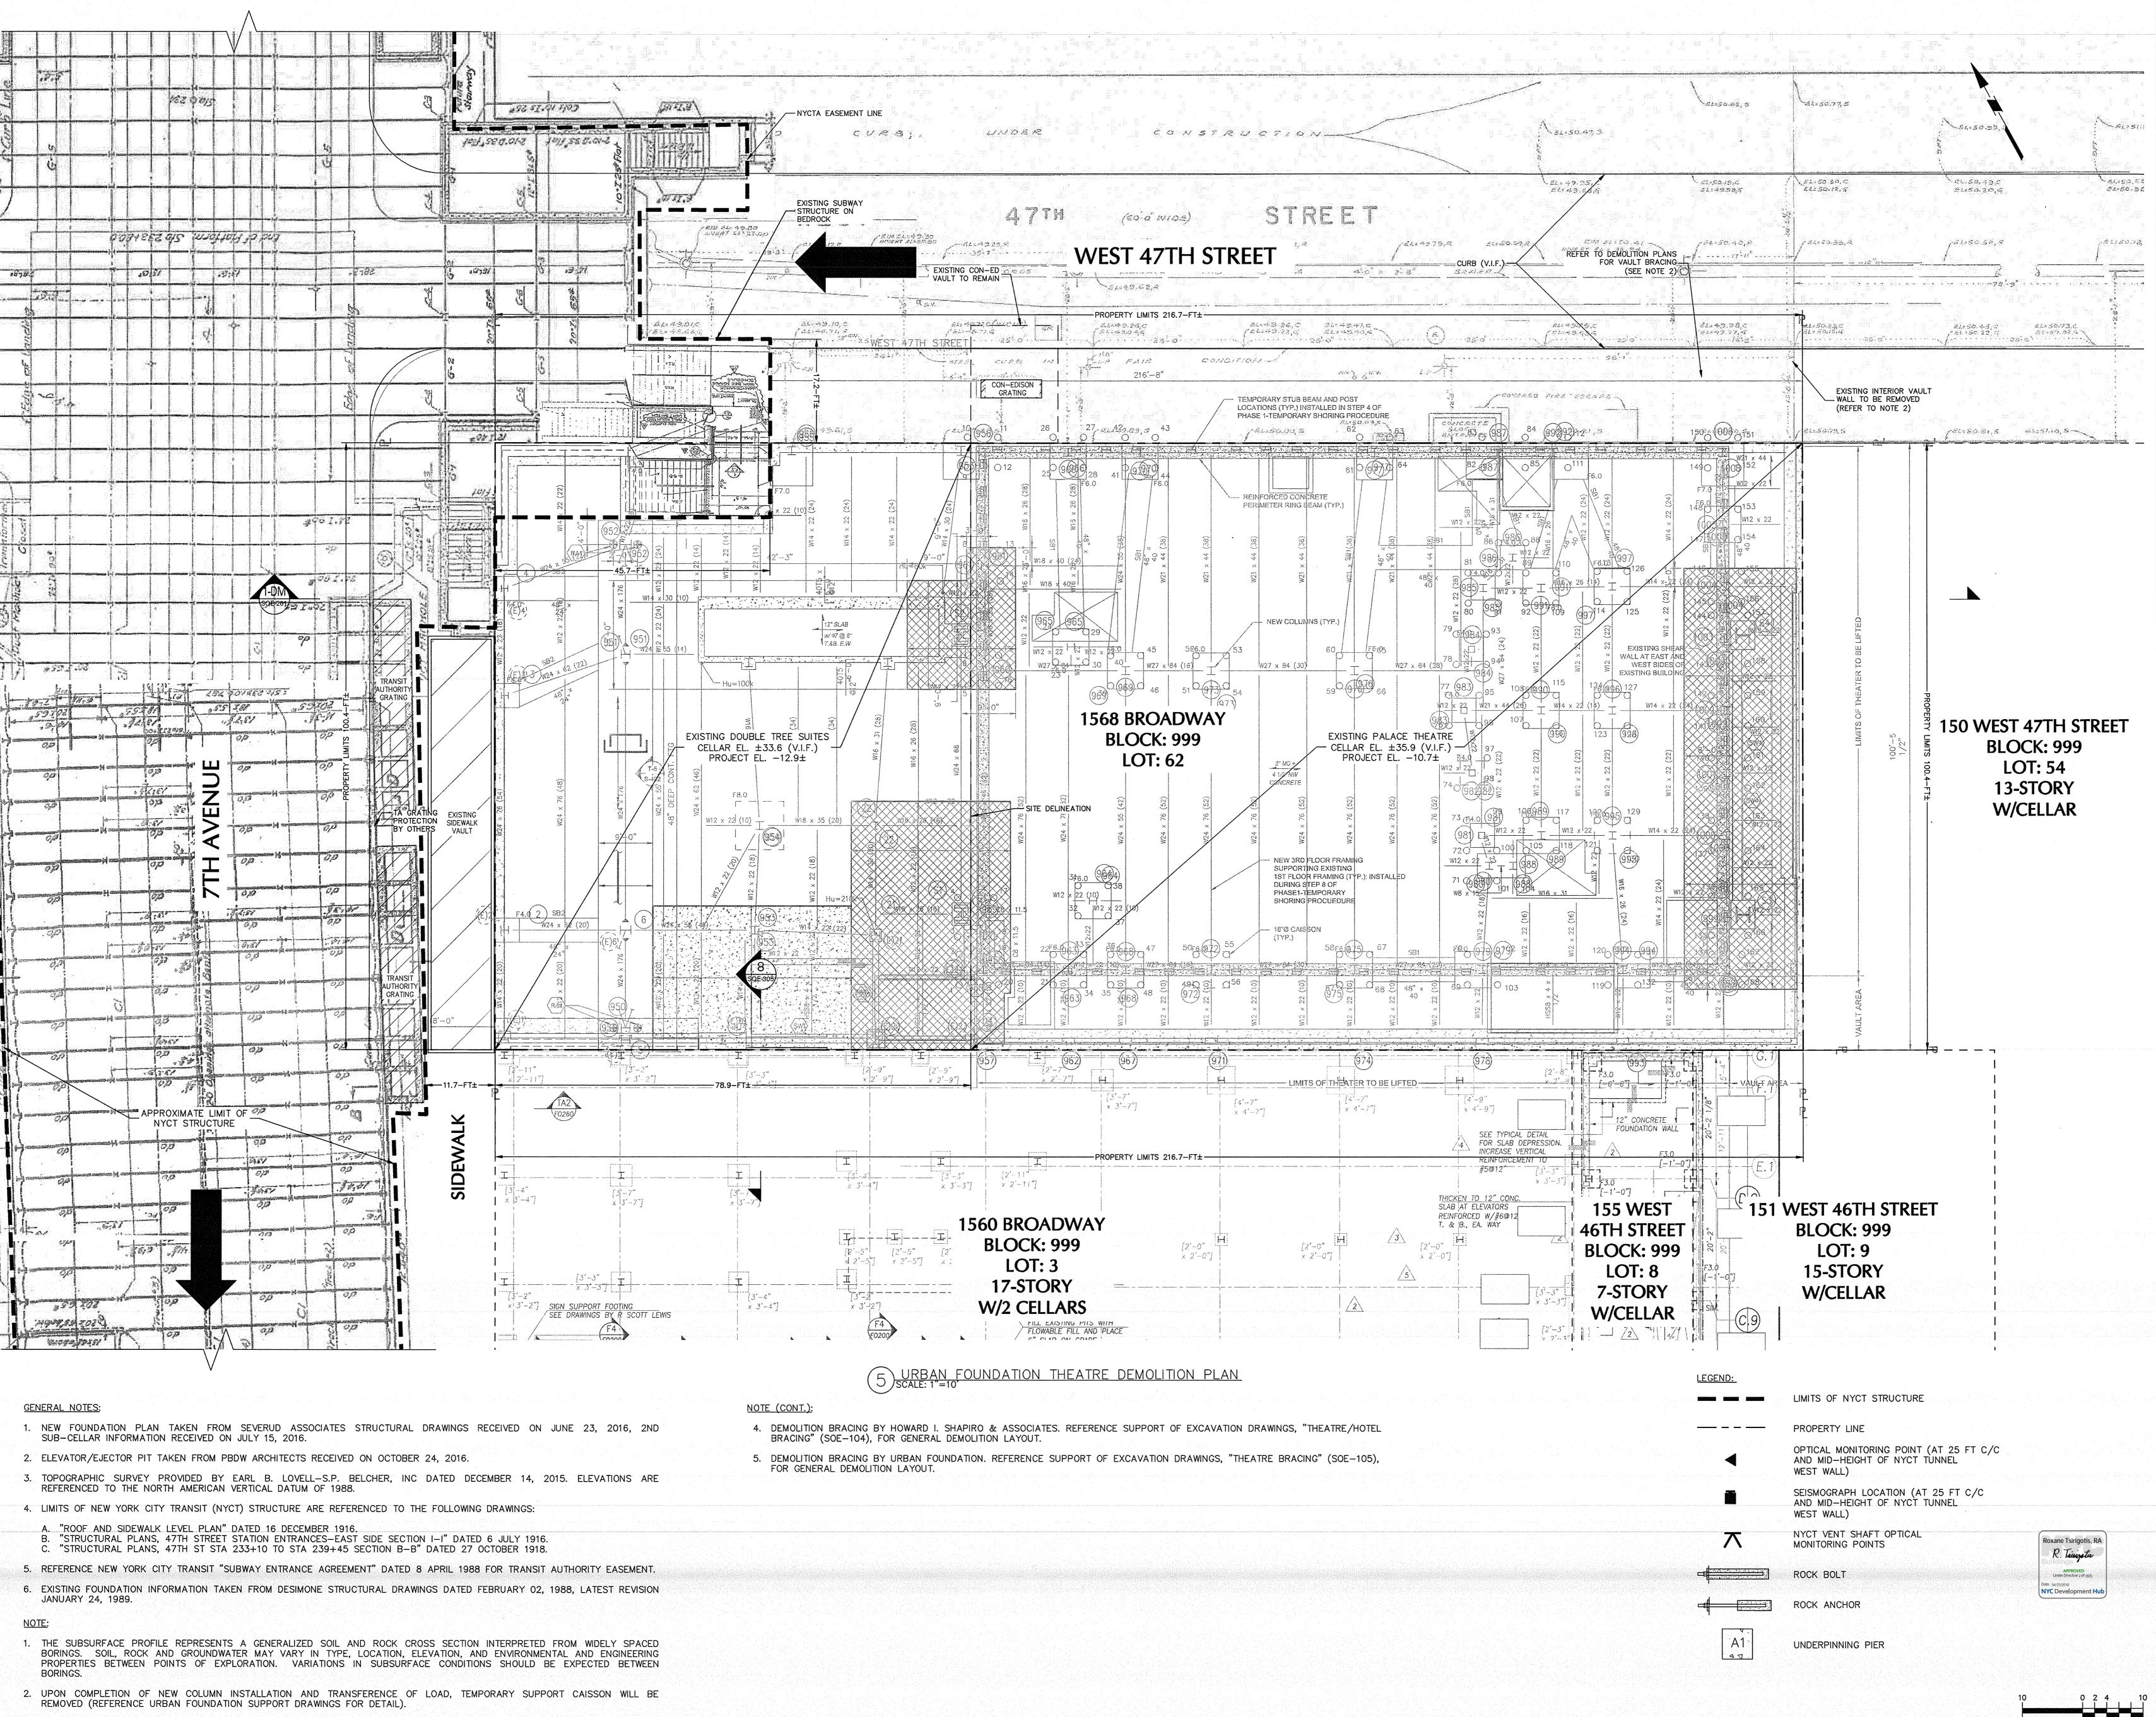
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Signature & Seal:

8 of 25

Sheet Number:

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# 1568 Broadway

New York, NY 10036

**URBAN FOUNDATION** THEATRE DEMOLITION

PLAN

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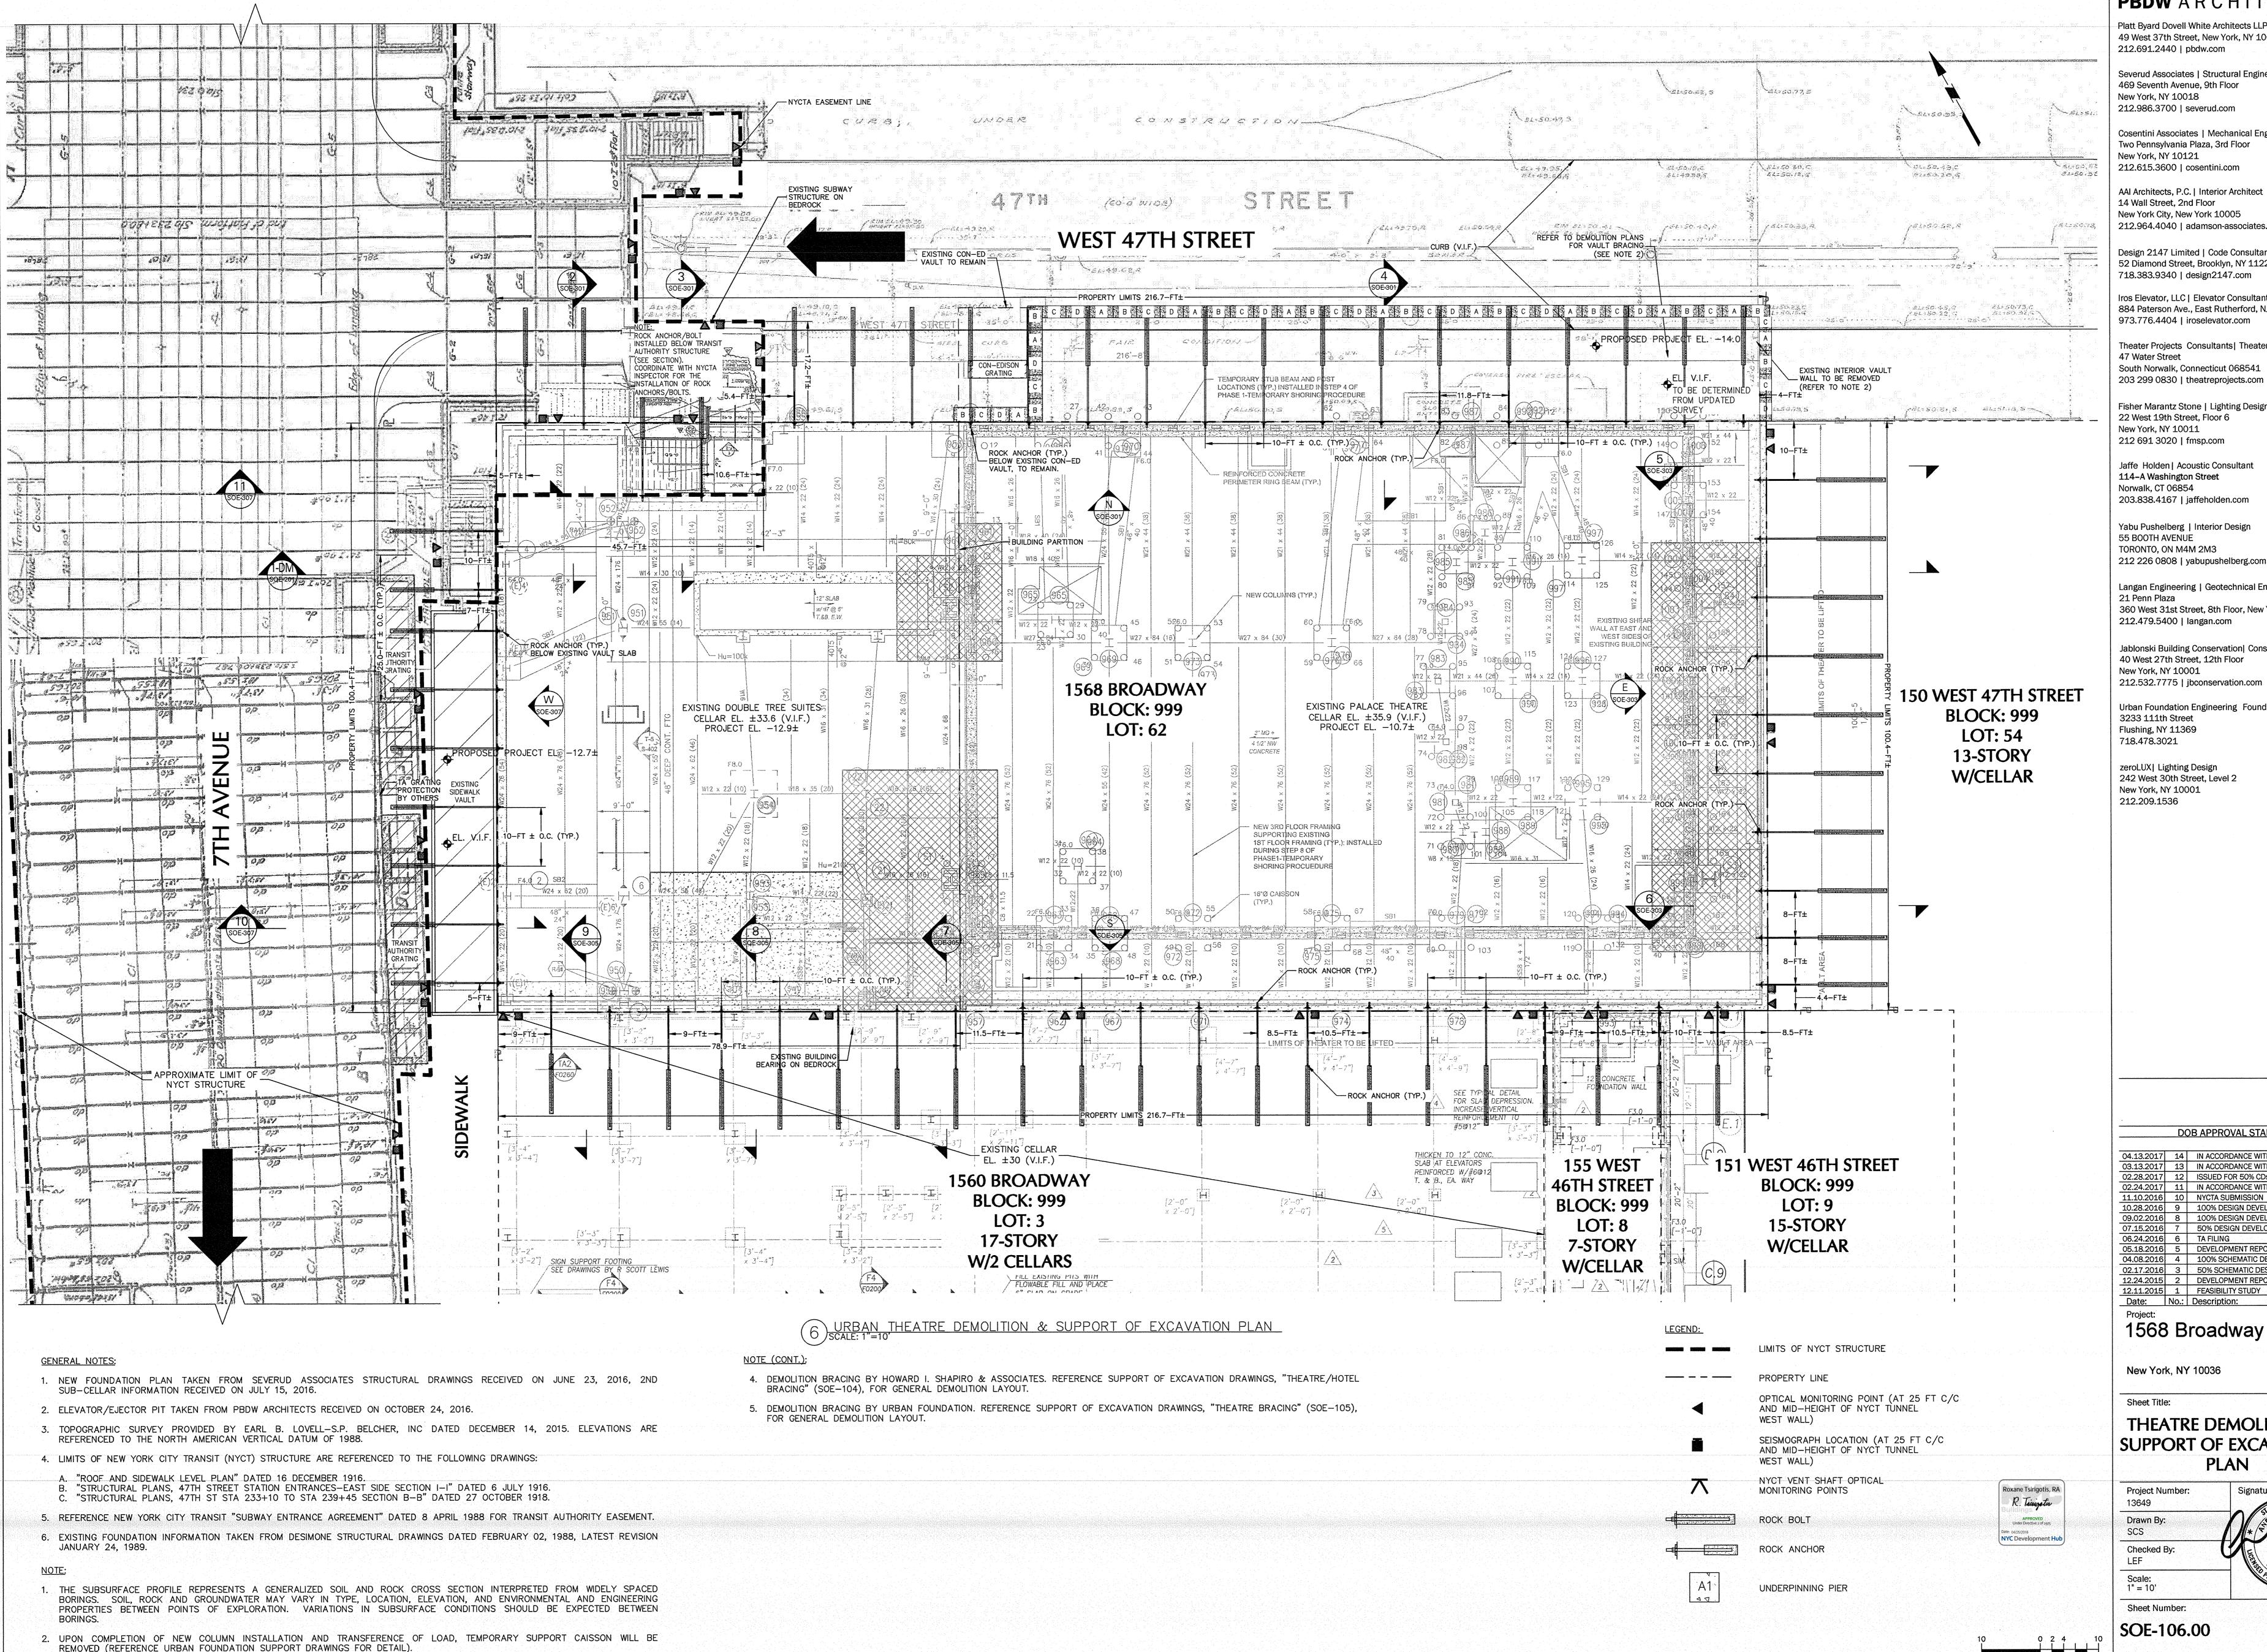
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Sheet Number: SOE-105.00

PHASE-3: EXCAVATION AND BRACING OF CAISSONS WHILE EXCAVATION

NYC DOB Number:

Sheet: 9 of 25



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THEATRE DEMOLITION & SUPPORT OF EXCAVATION PLAN

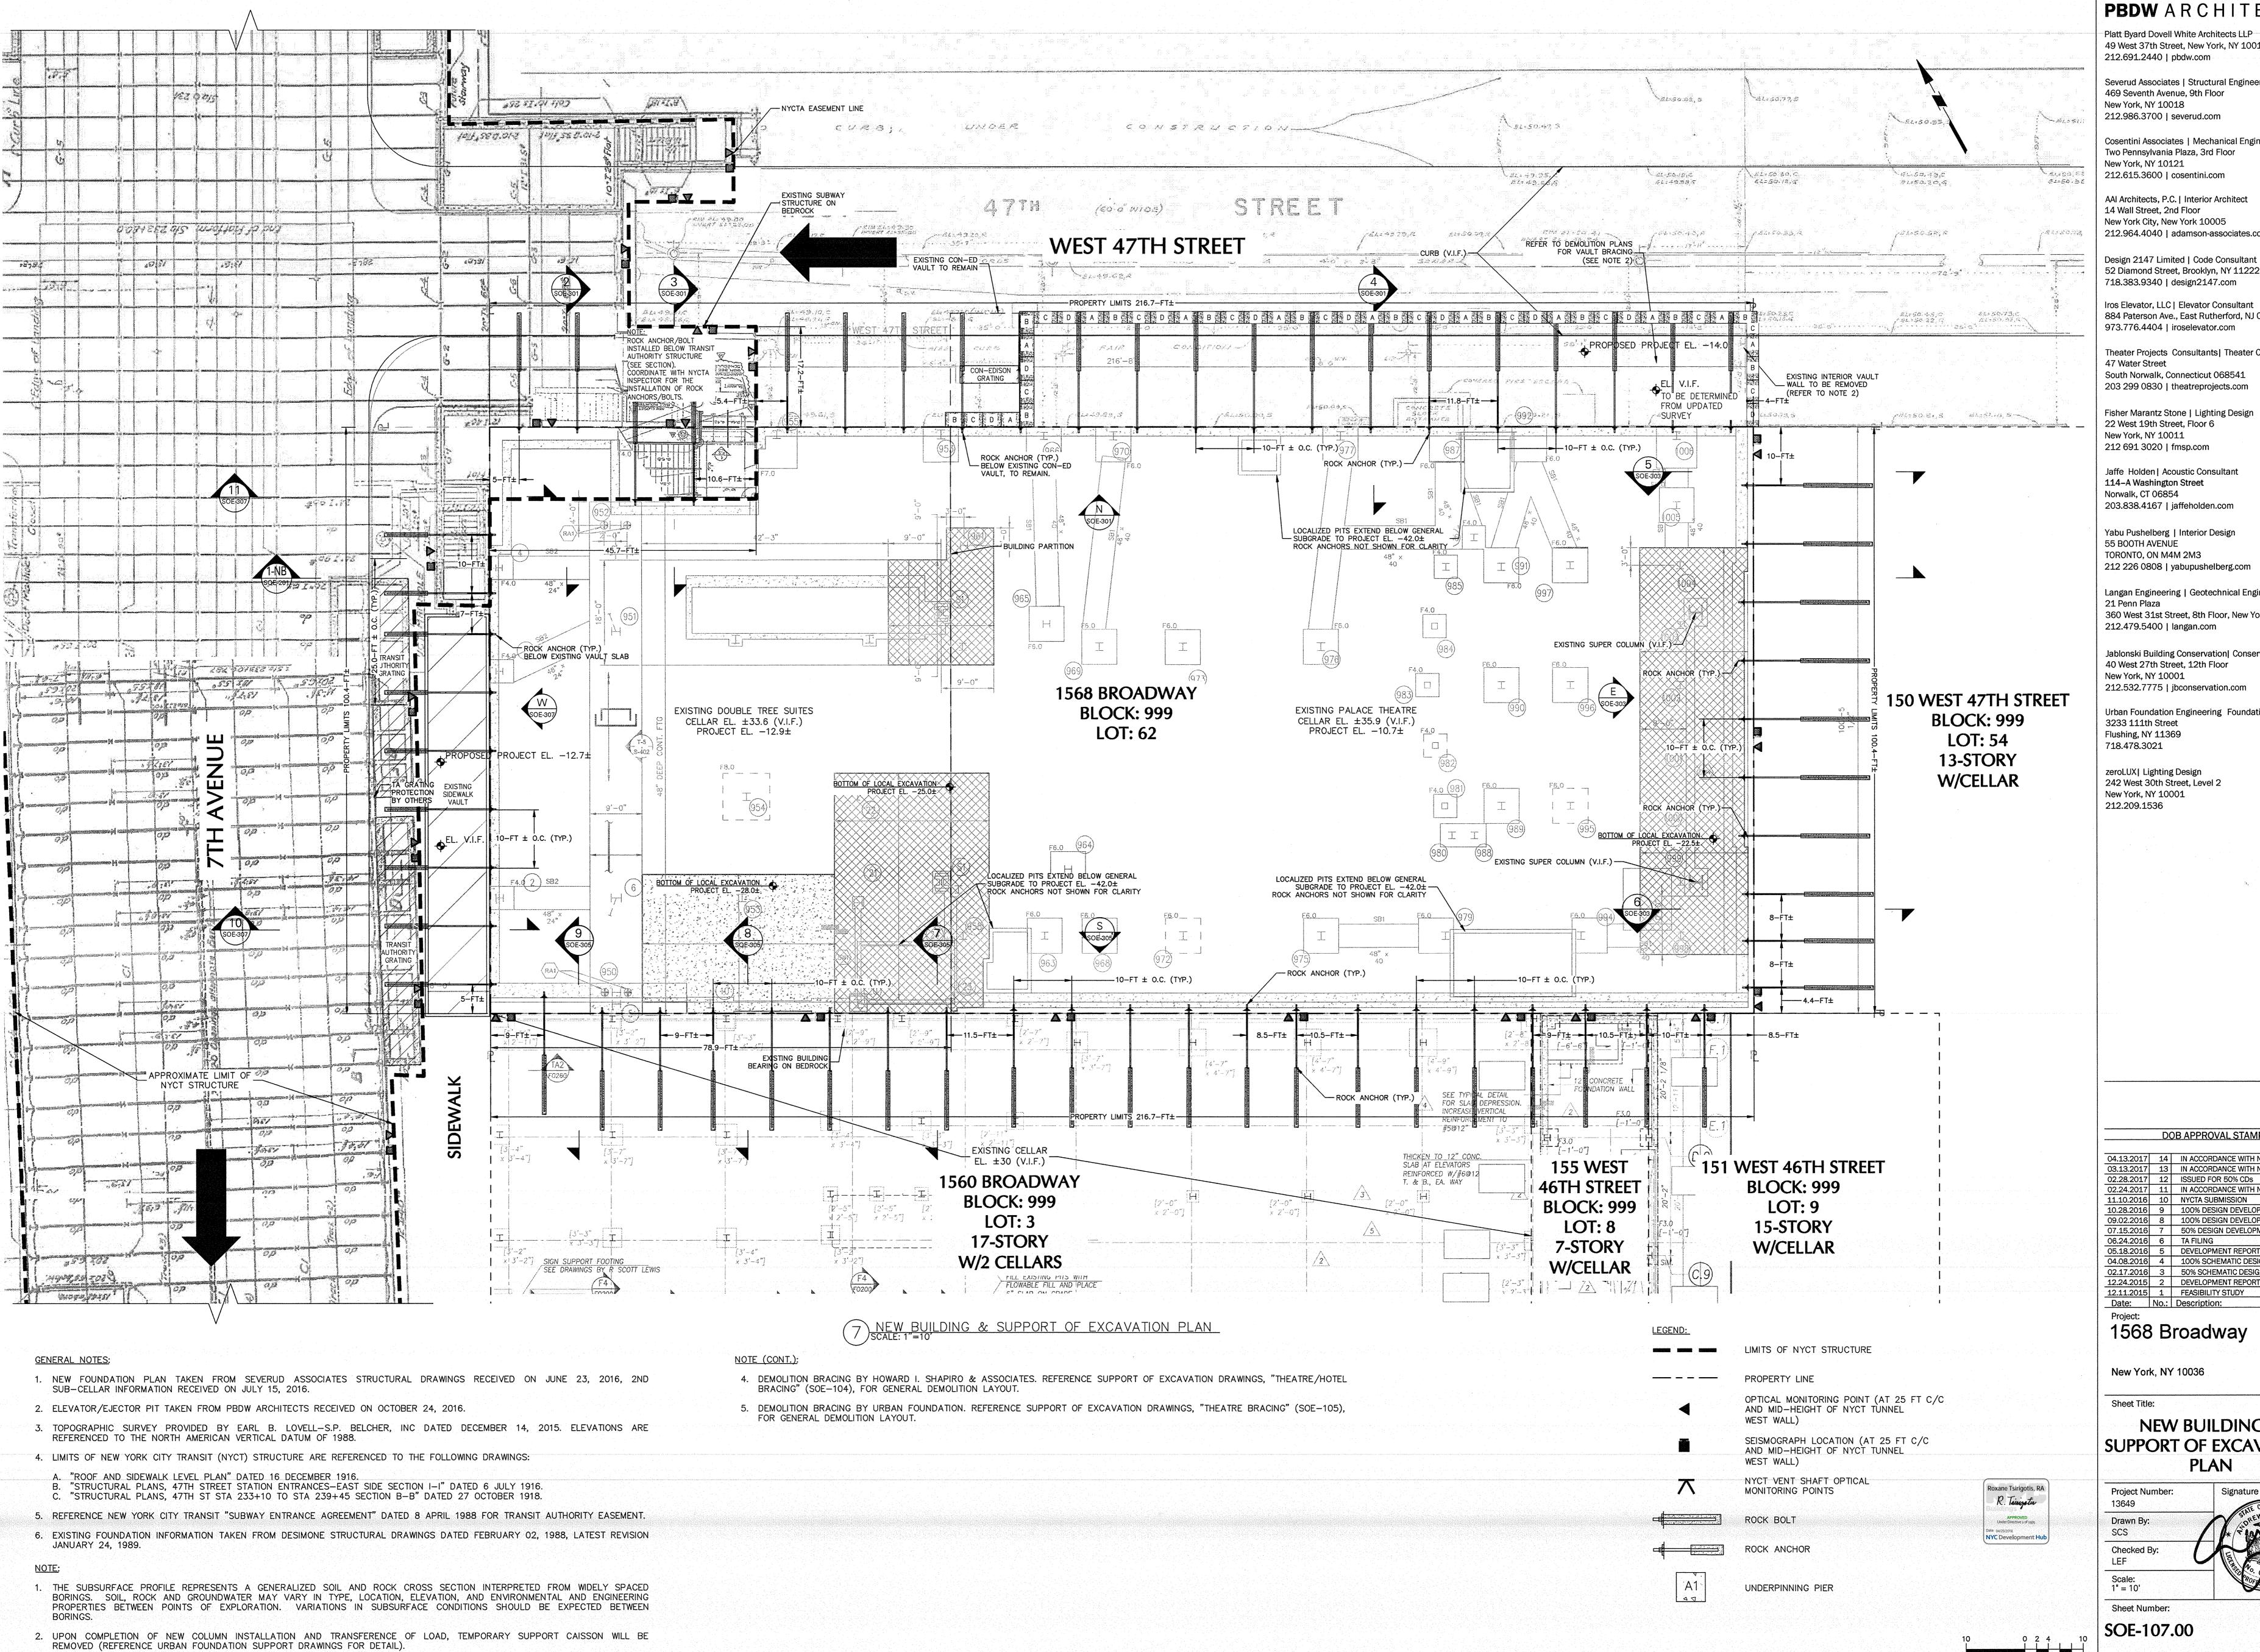
Signature & Seal:

10 of 25

Project Number: 13649 Drawn By: SCS Checked By:

Sheet Number:

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12.24.2015 2 DEVELOPMENT REPOR 12.11.2015 1 FEASIBILITY STUDY

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NEW BUILDING & SUPPORT OF EXCAVATION PLAN

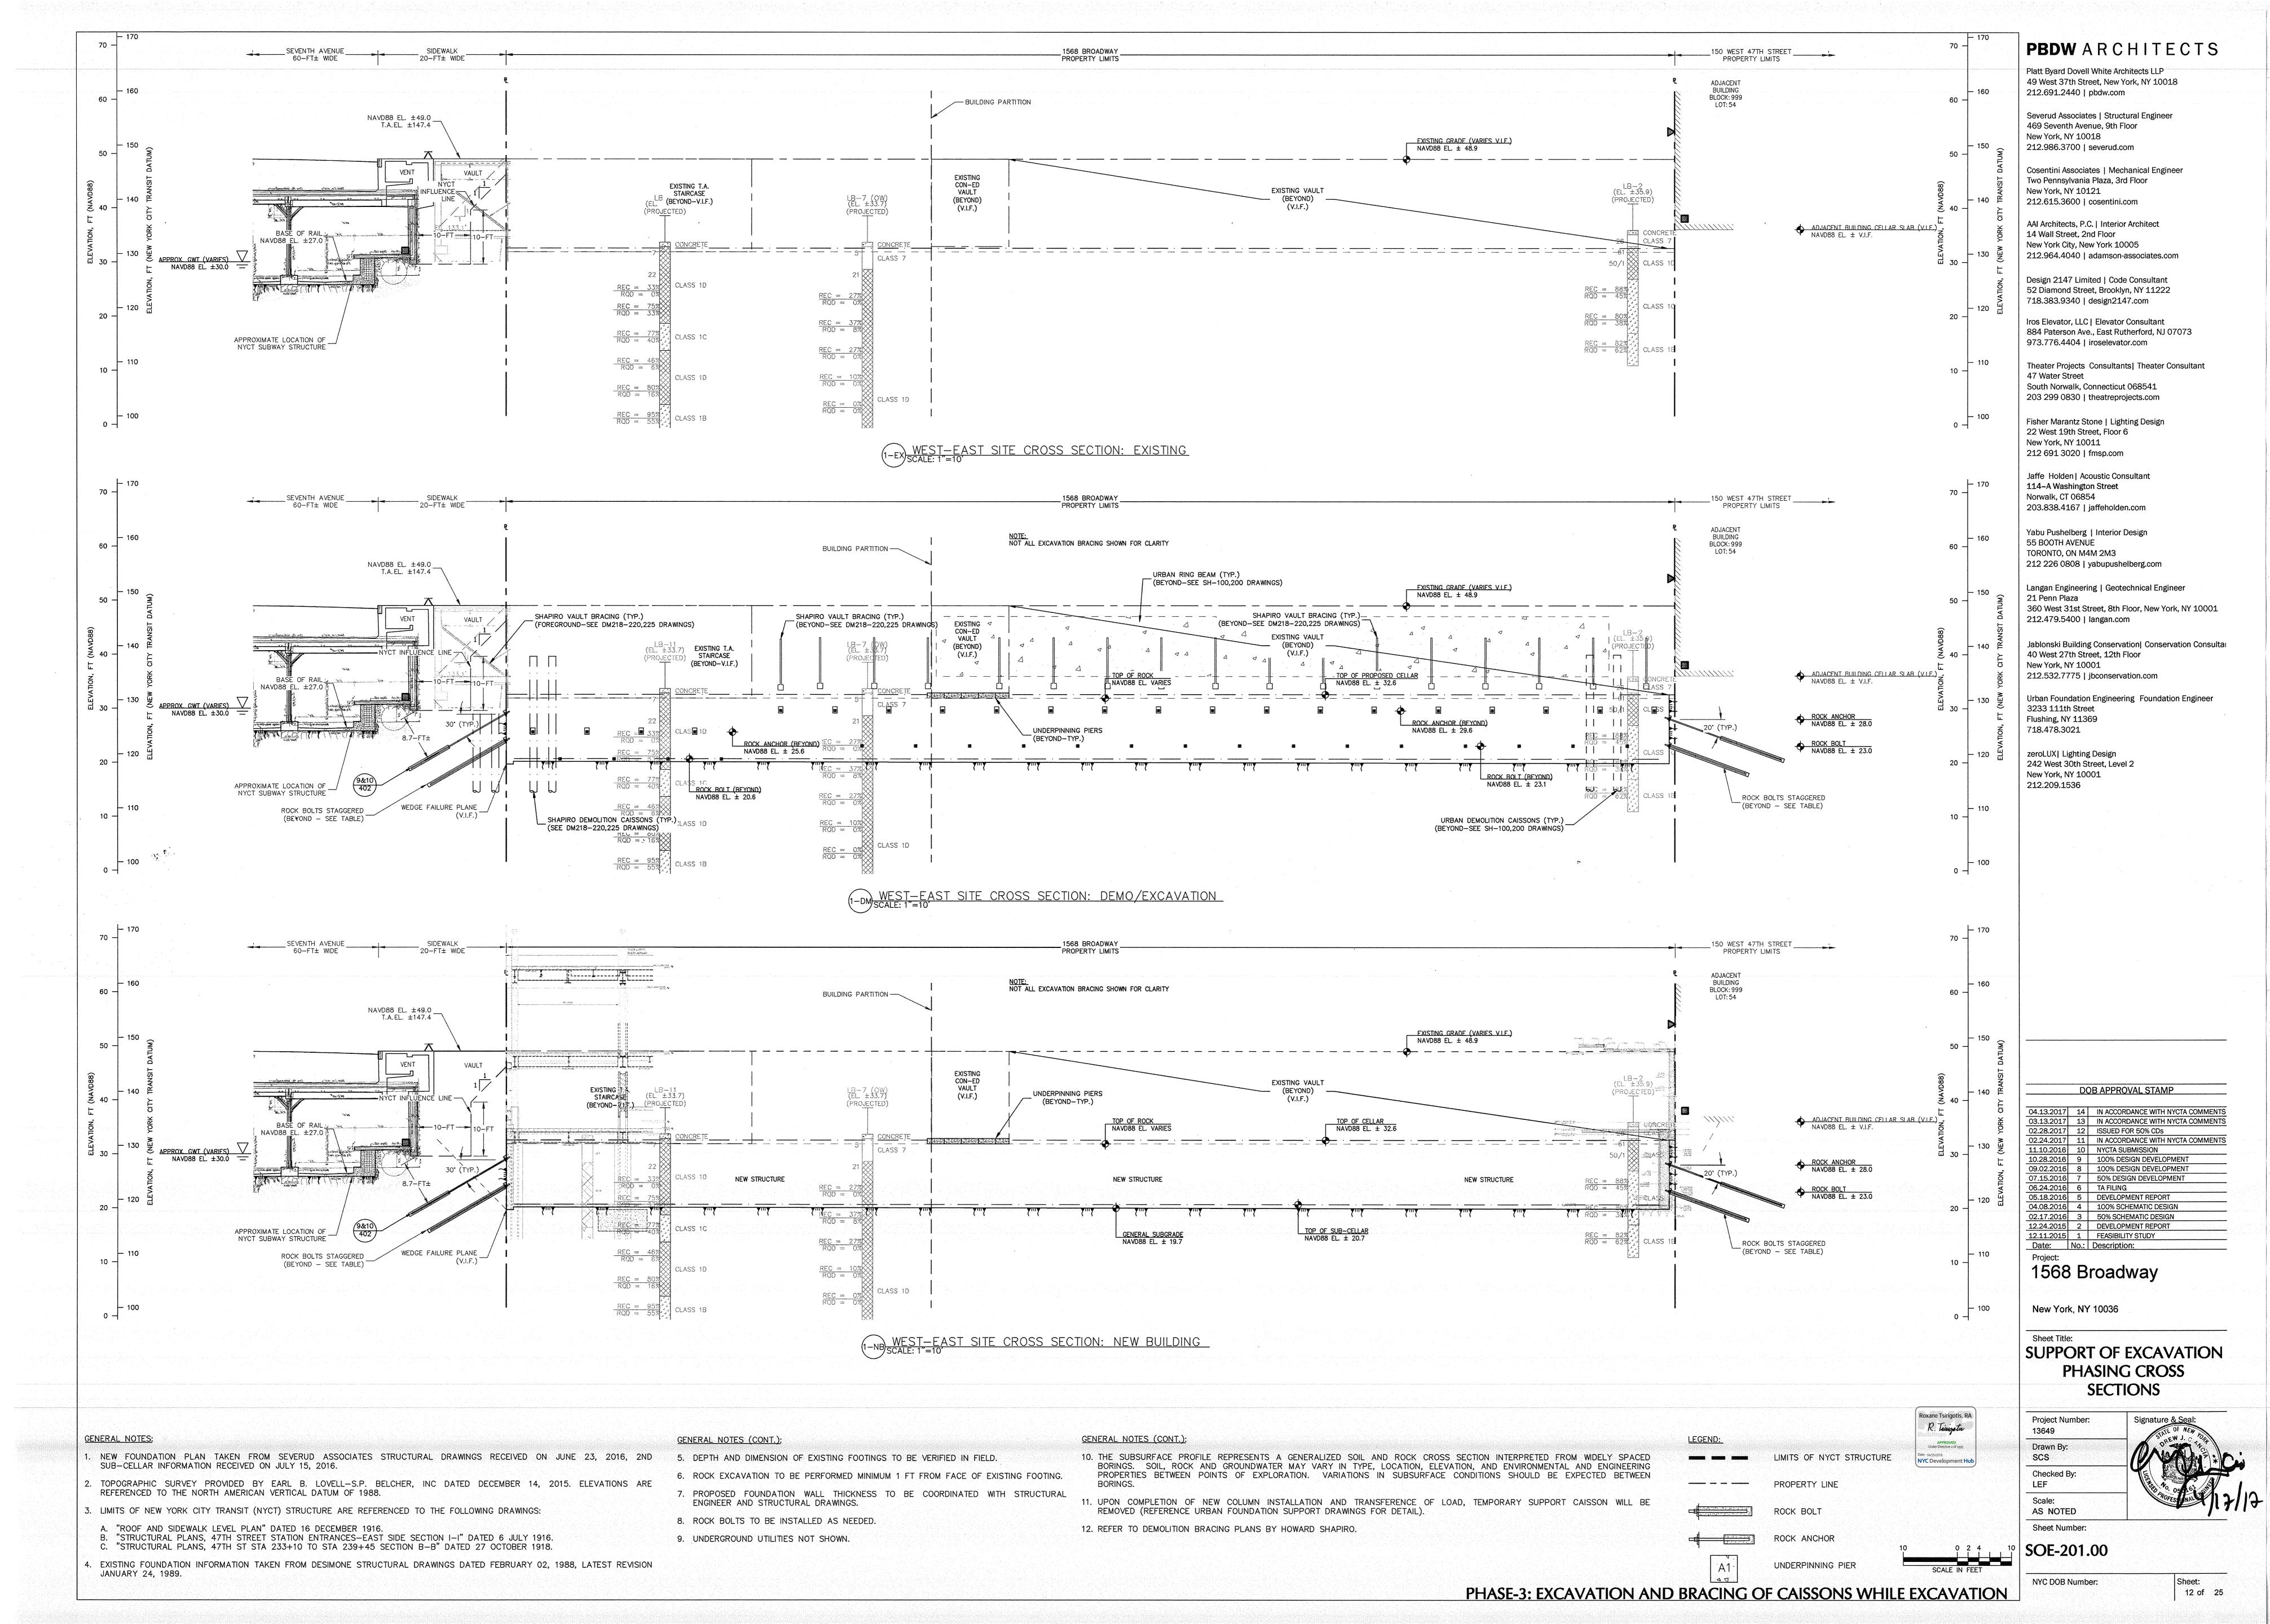
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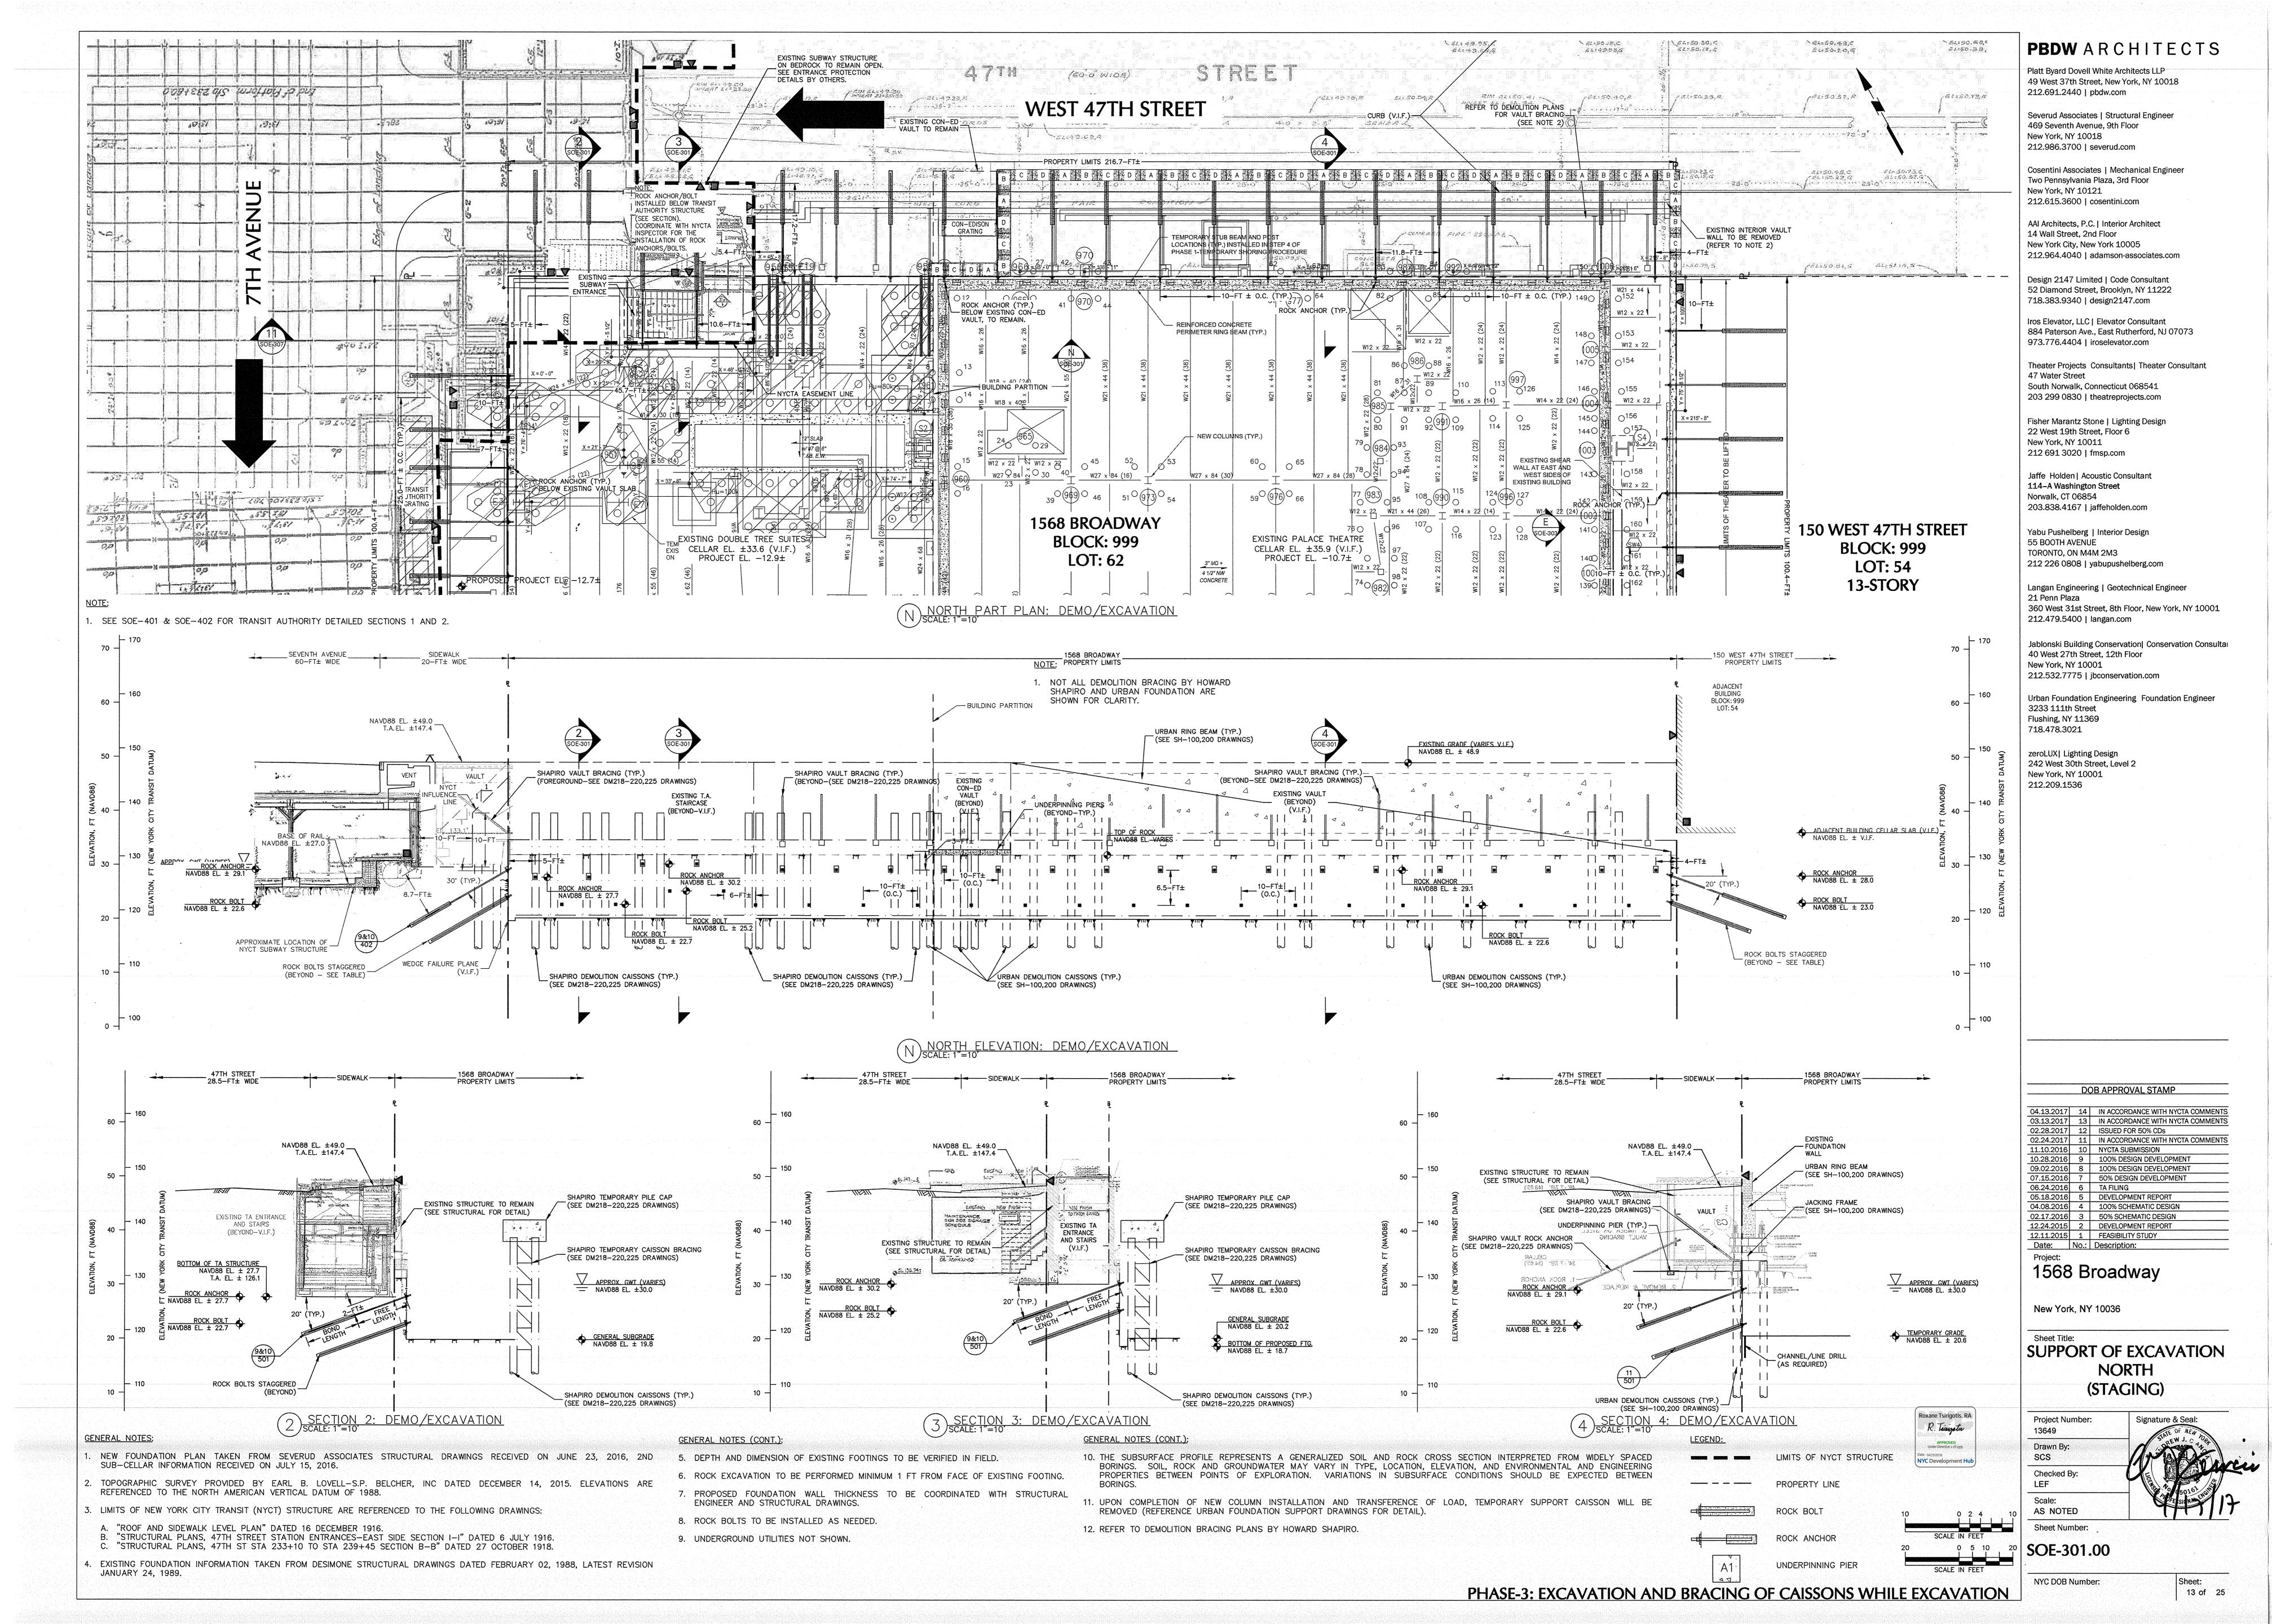
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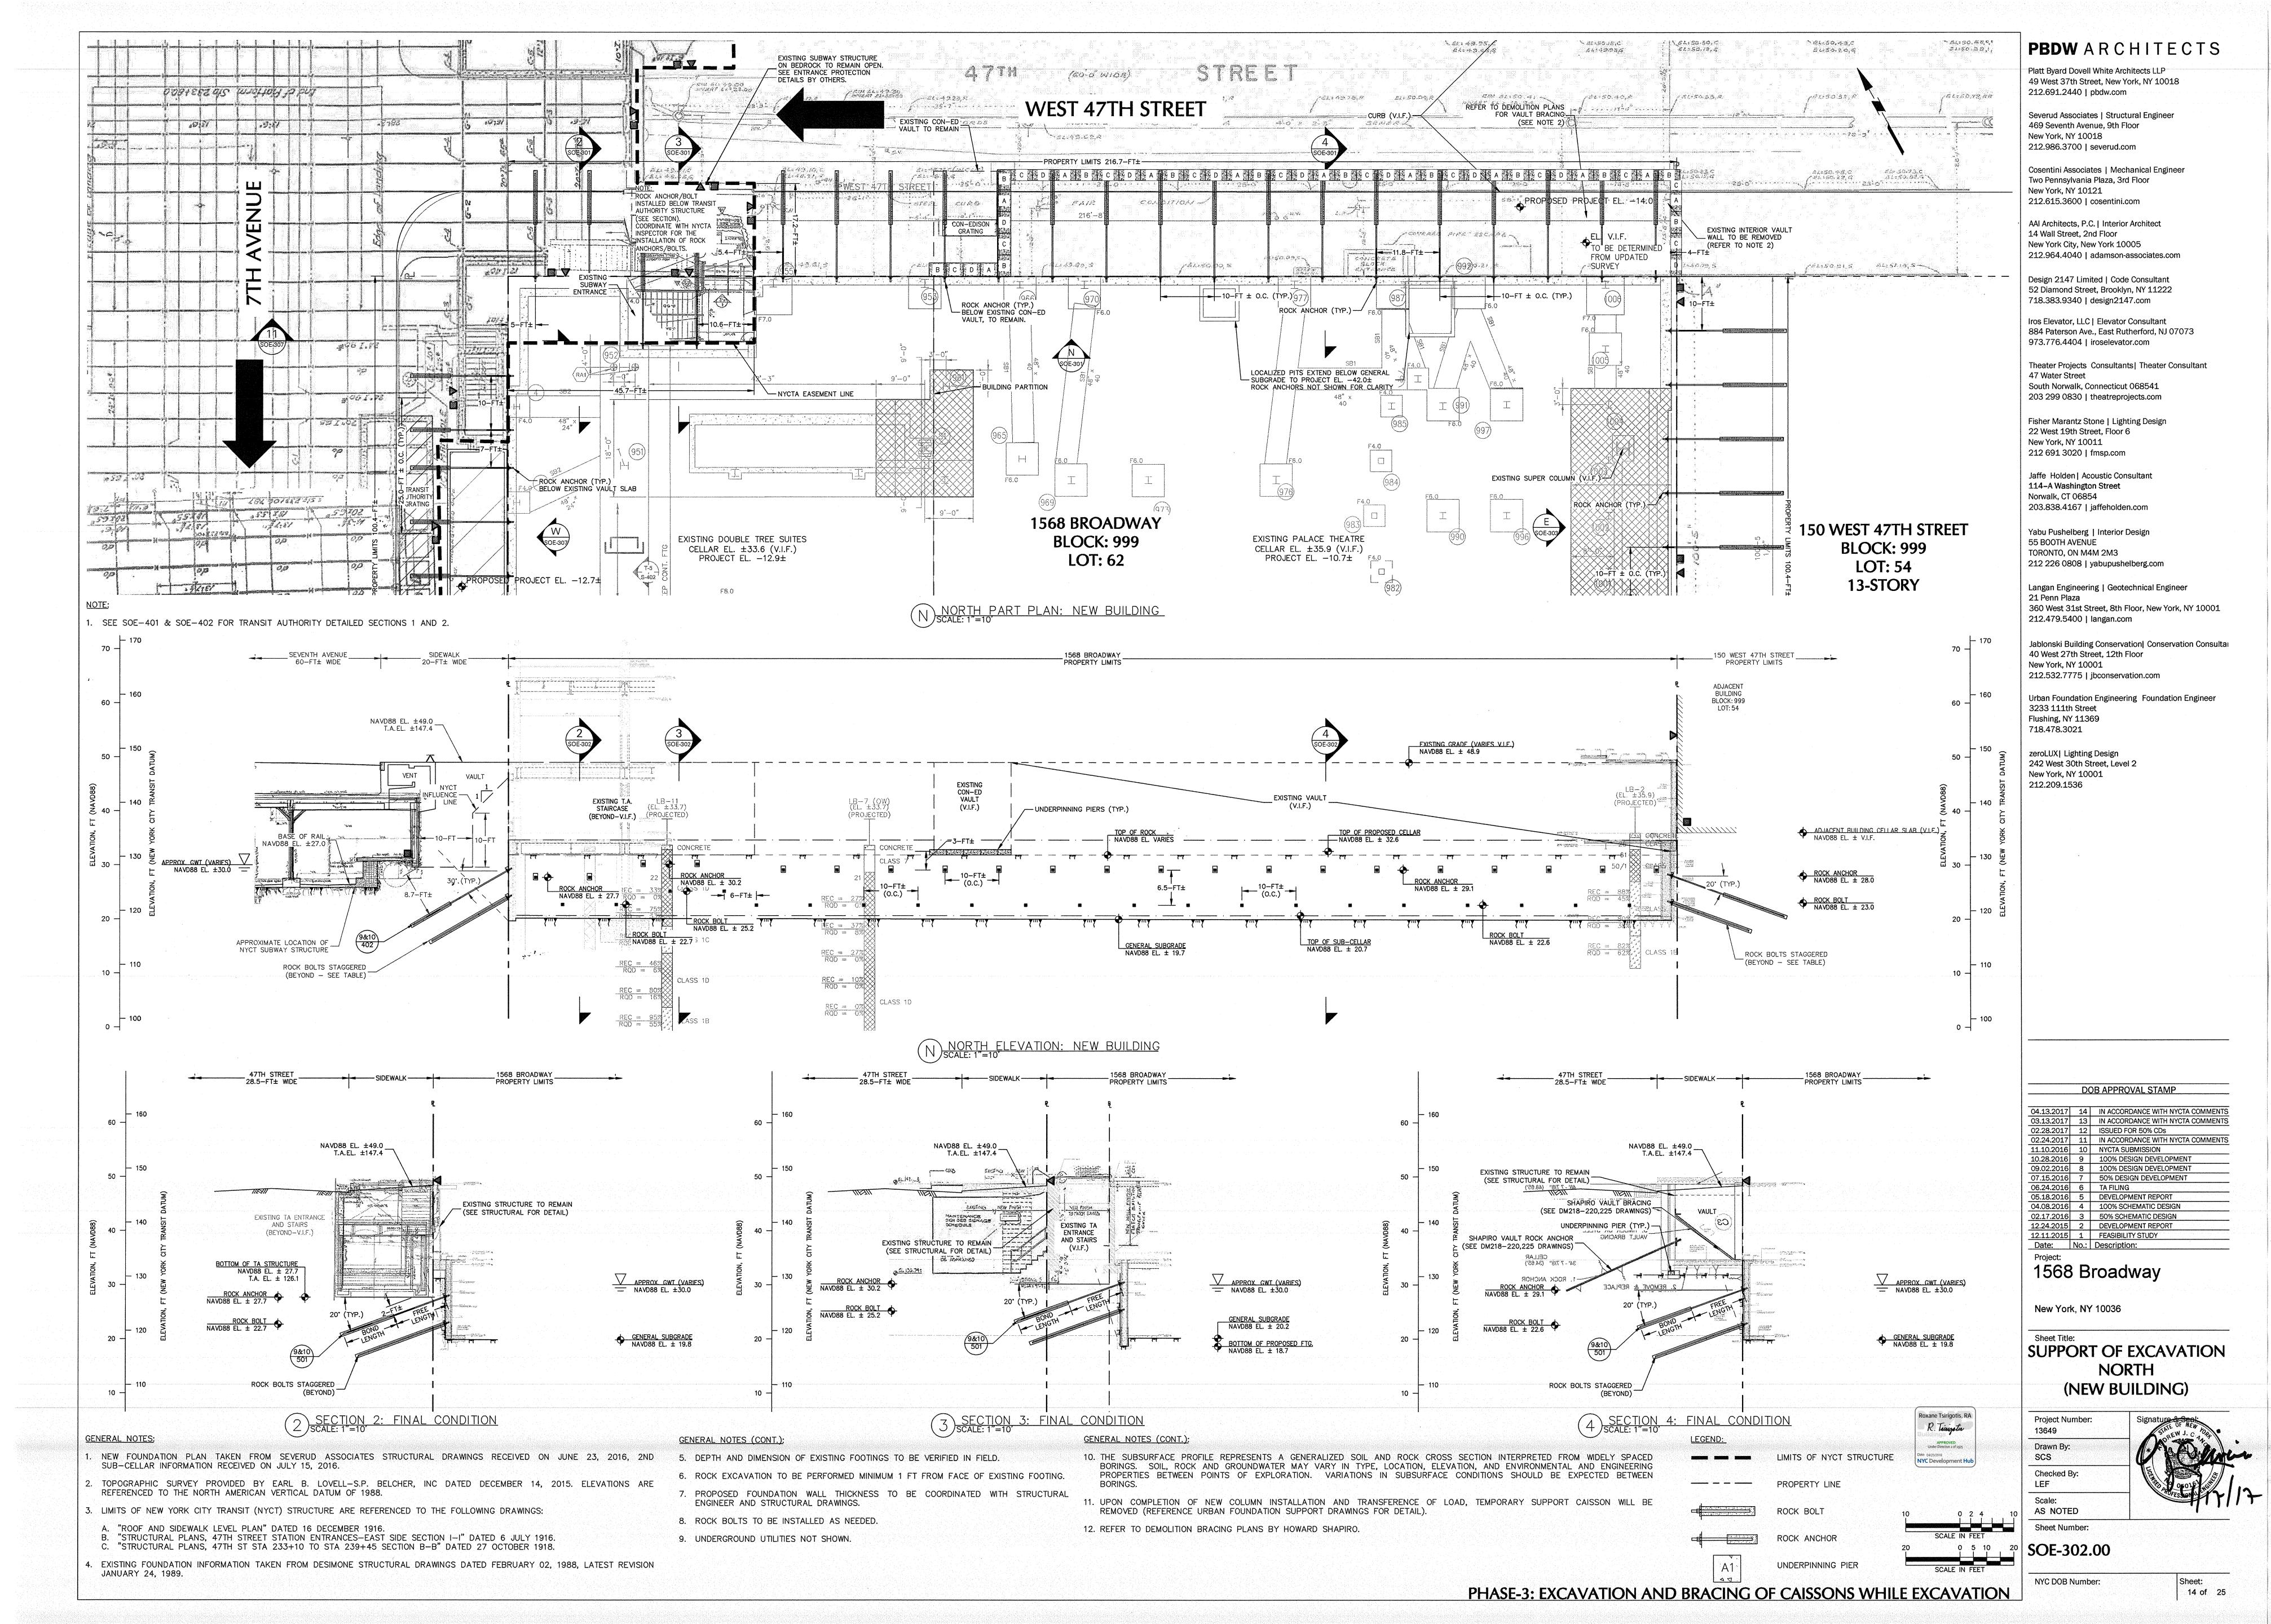
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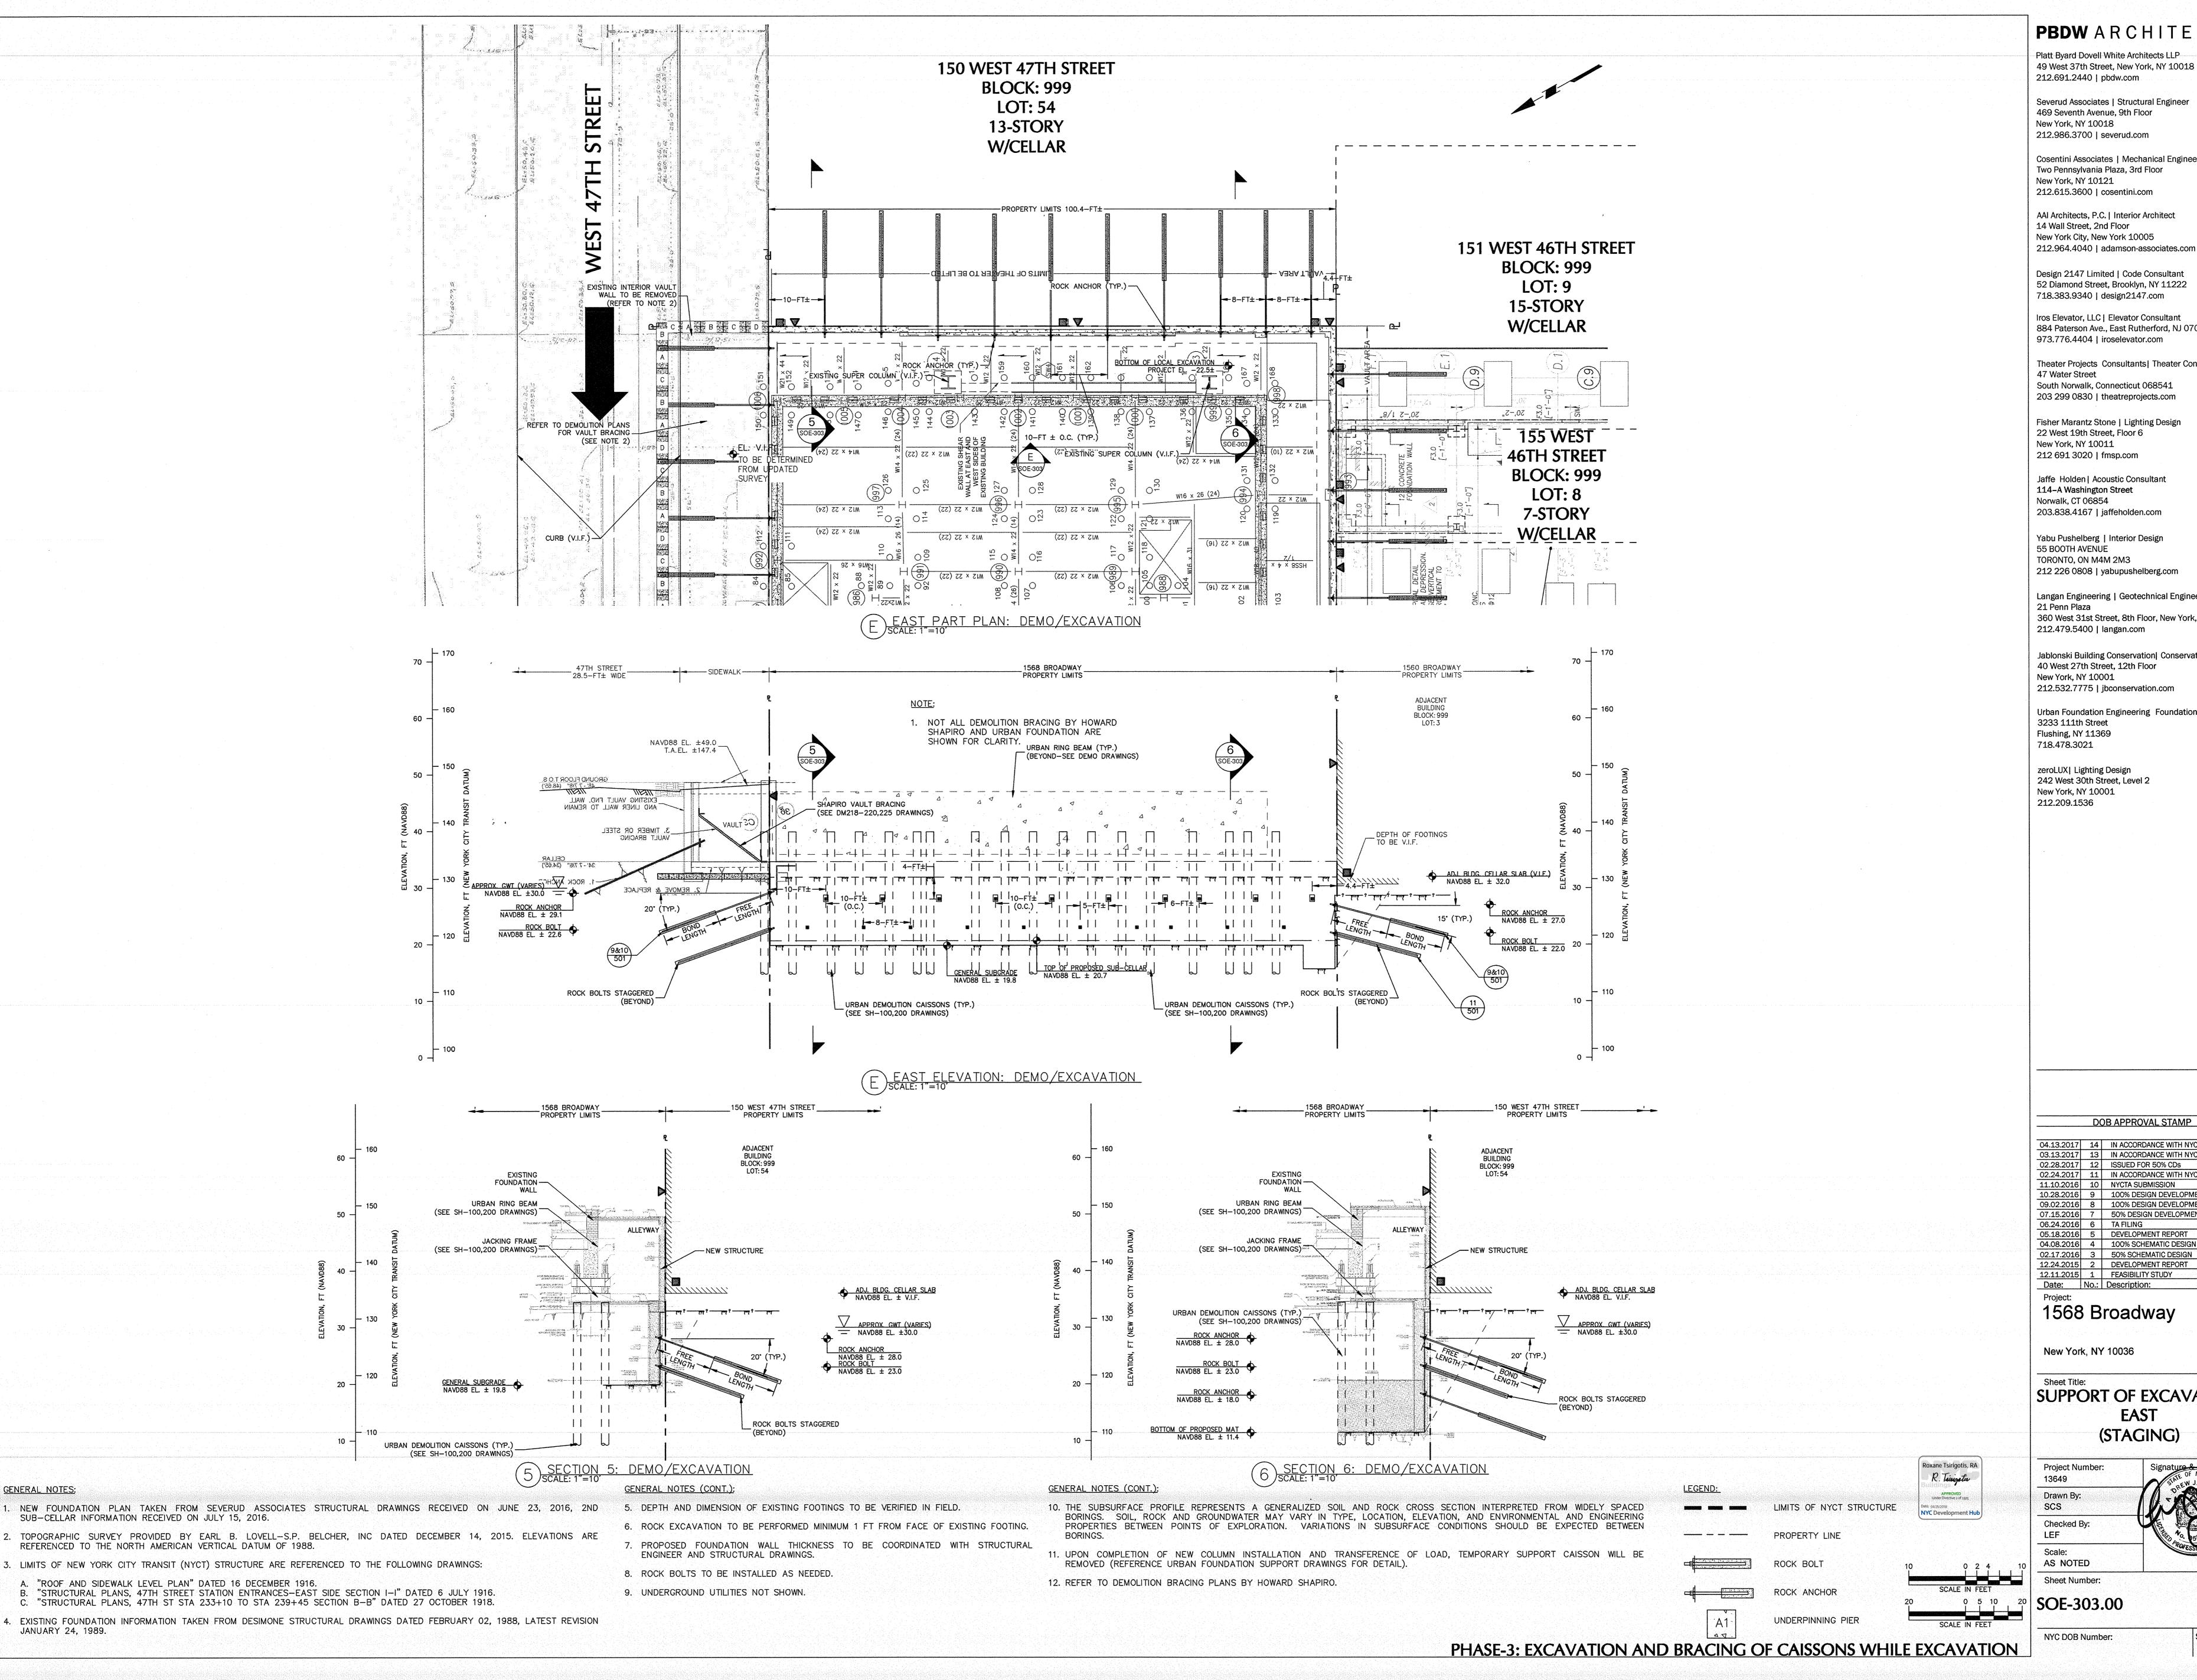
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NYC DOB Number: 11 of 25









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New York, NY 10036

SUPPORT OF EXCAVATION (STAGING)

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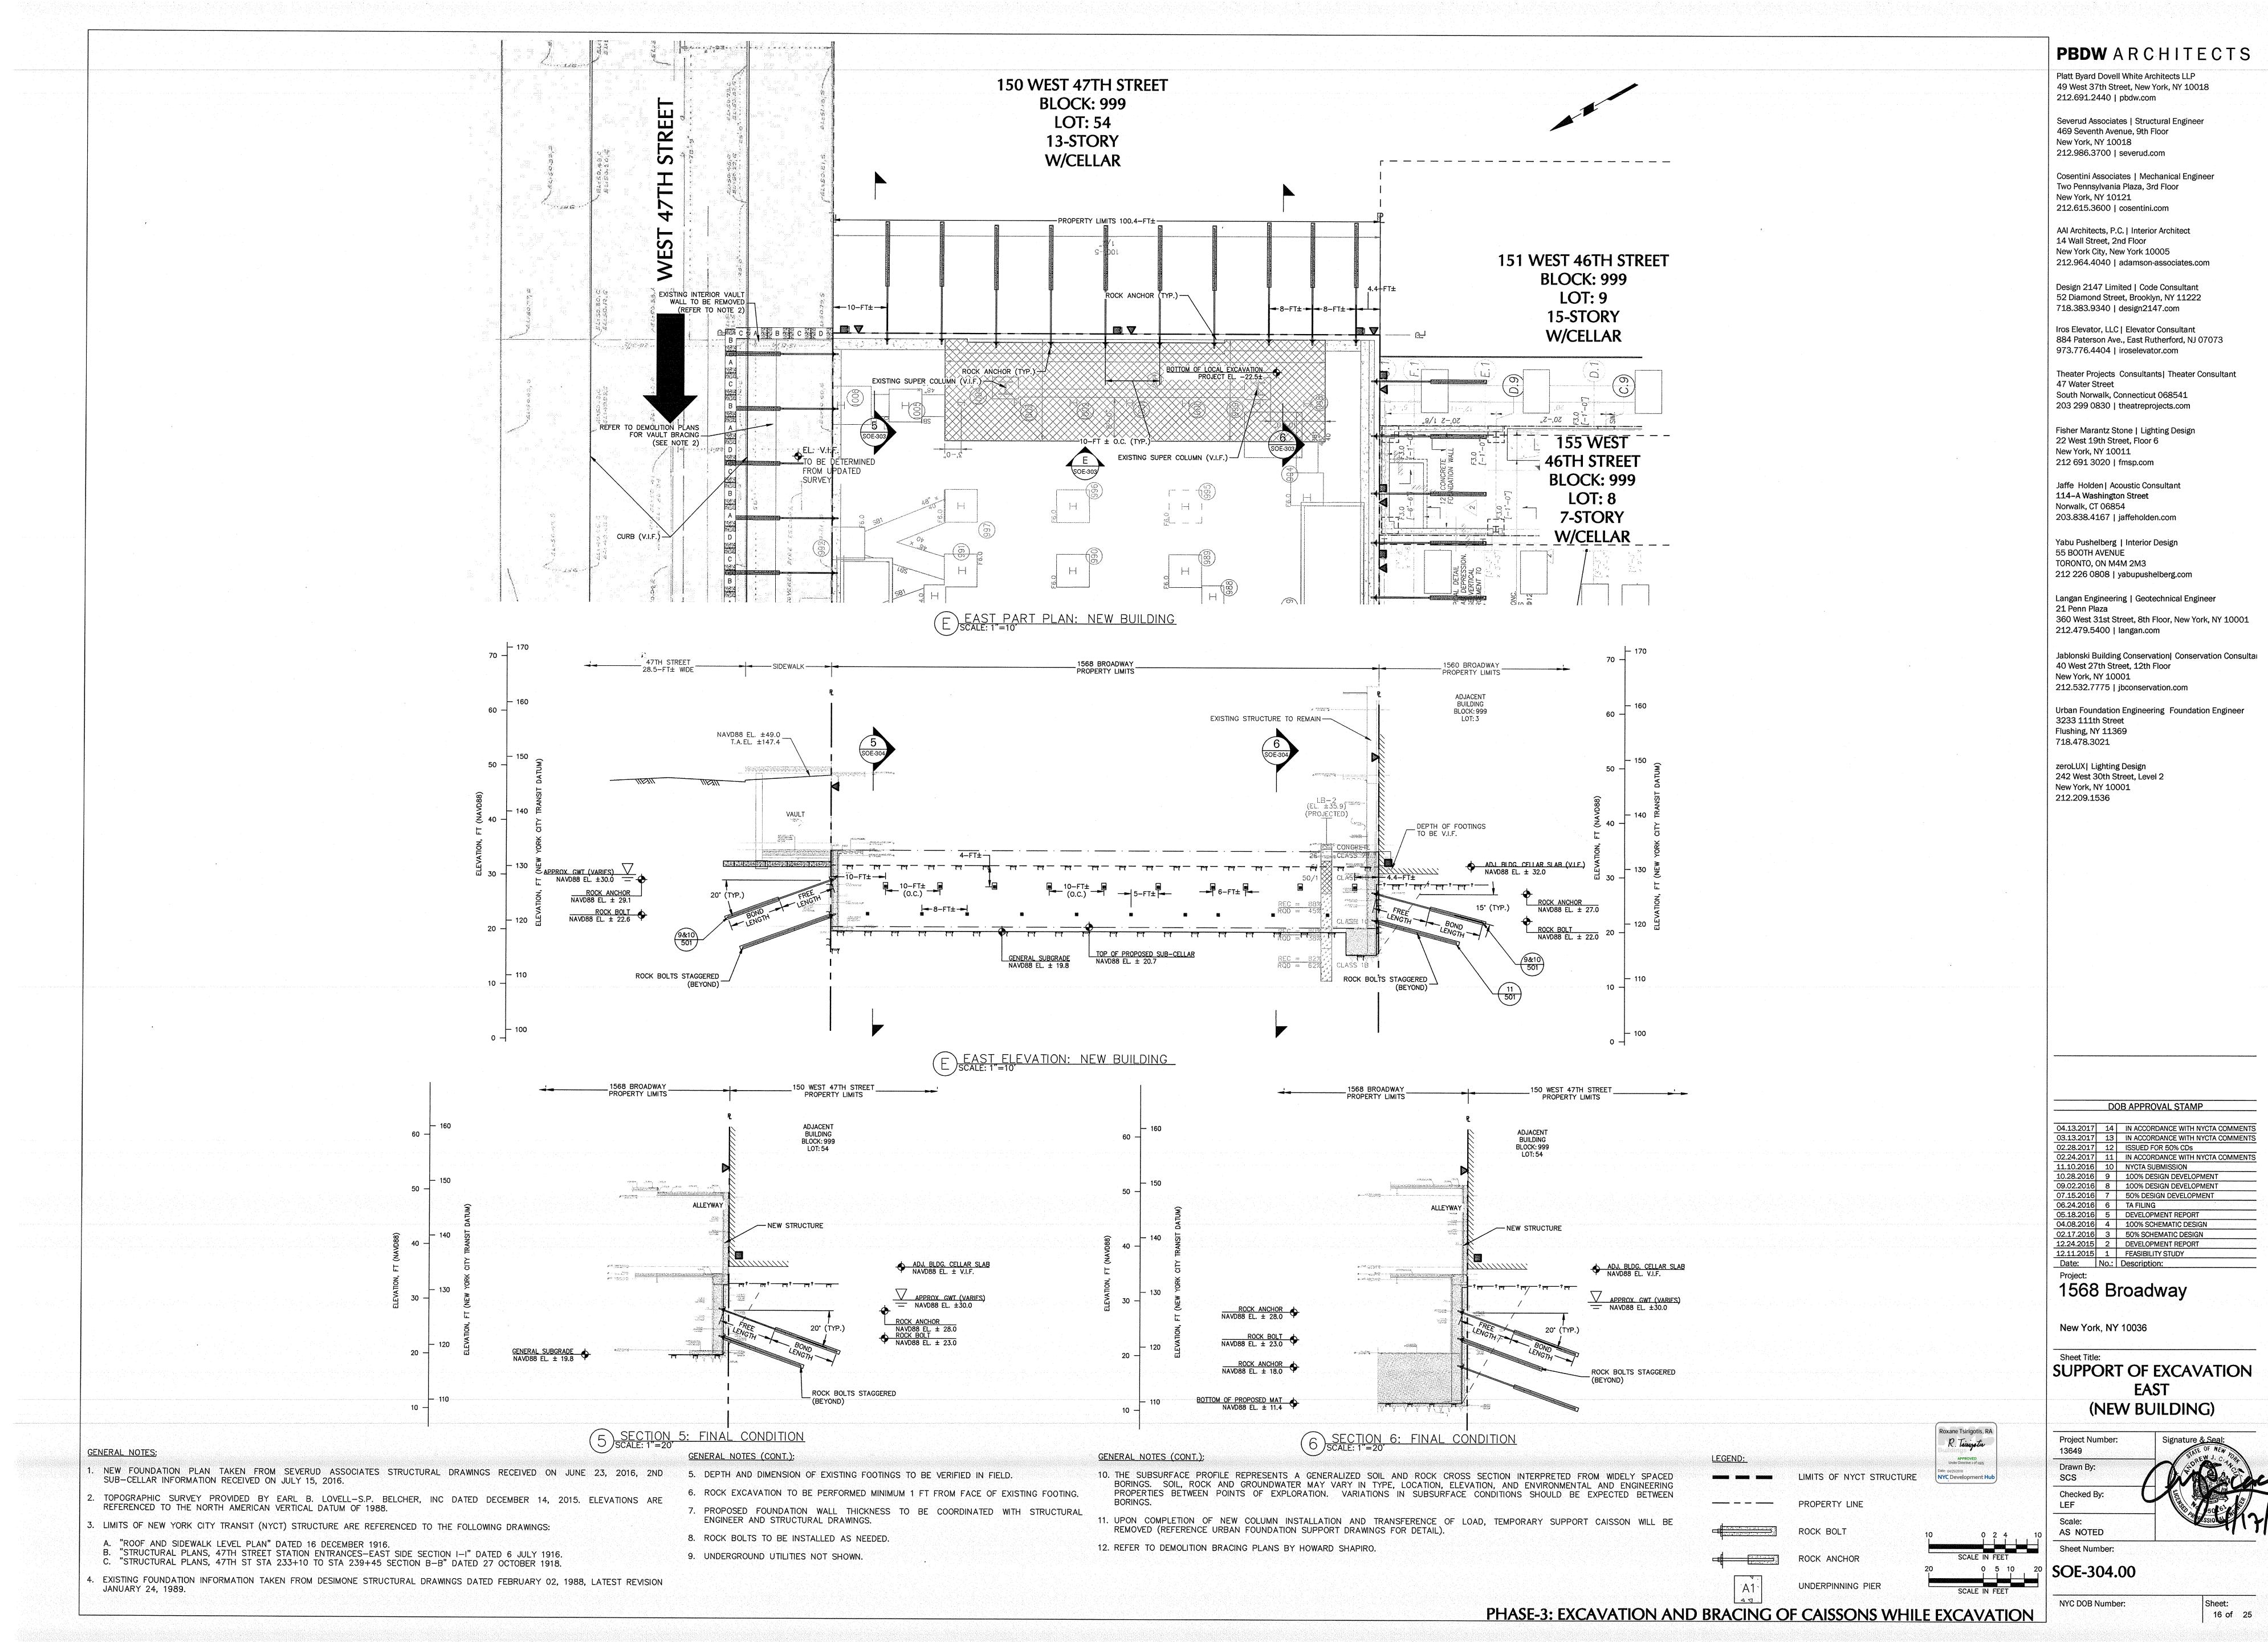
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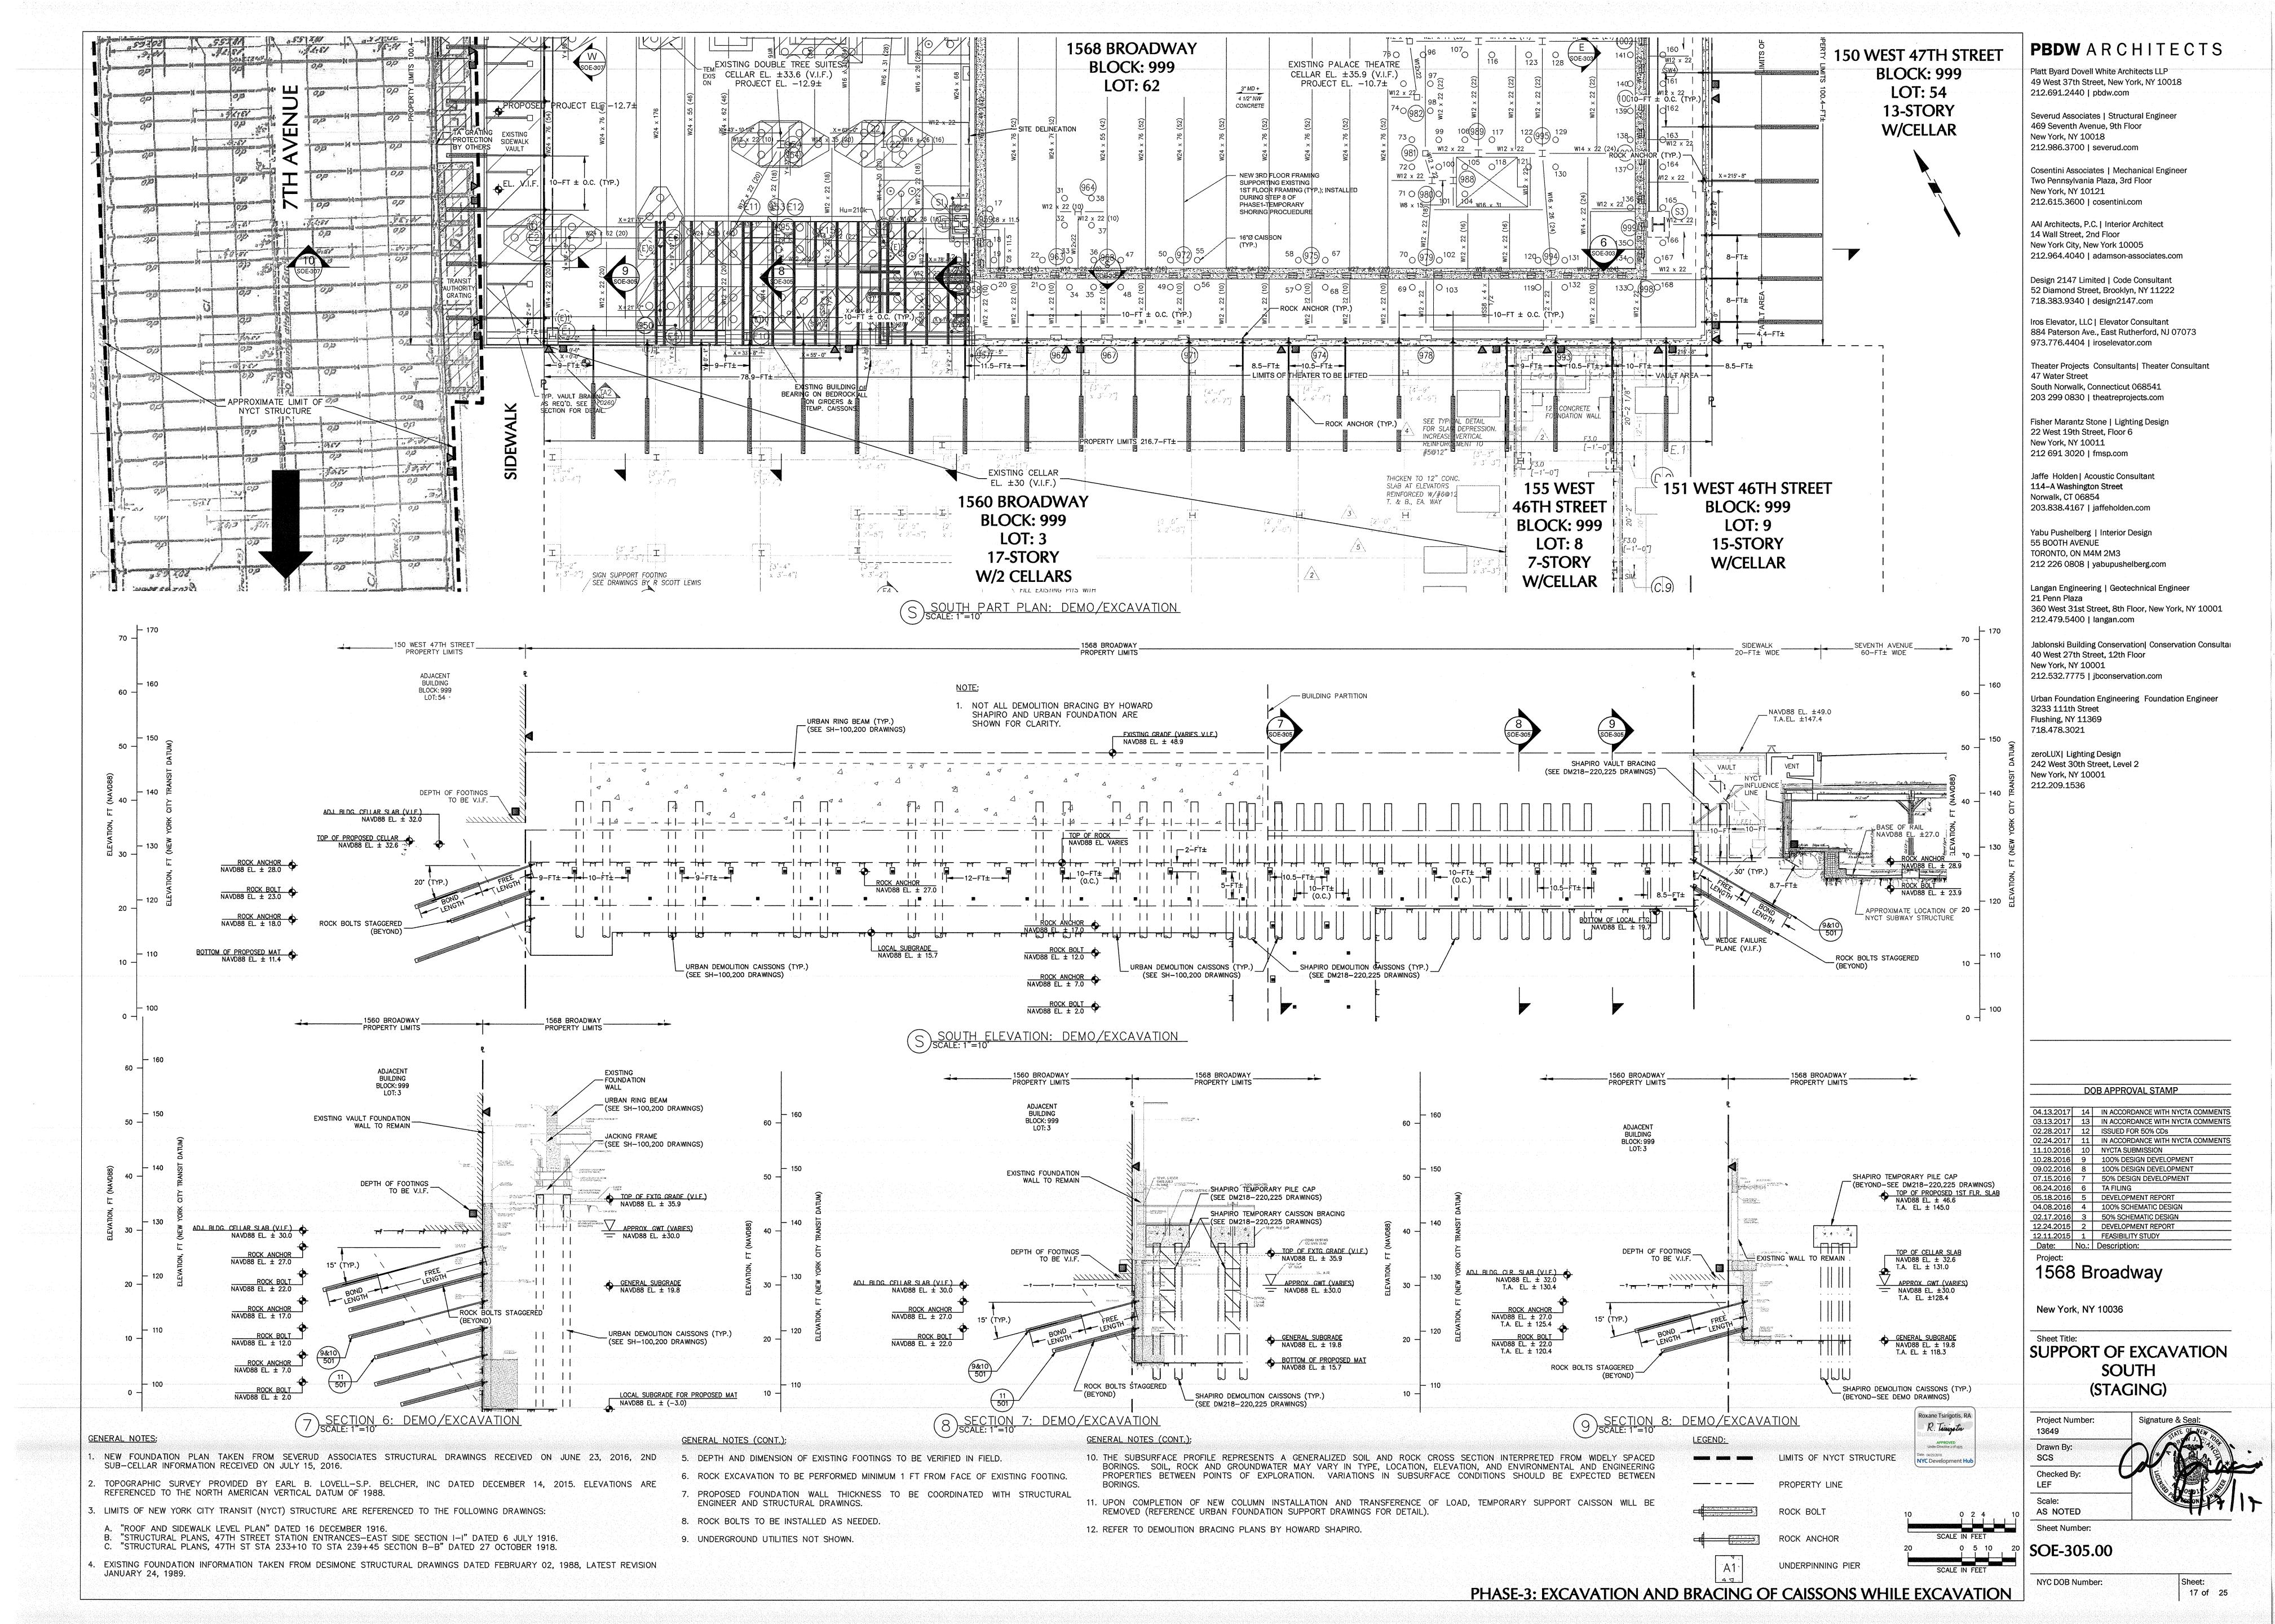
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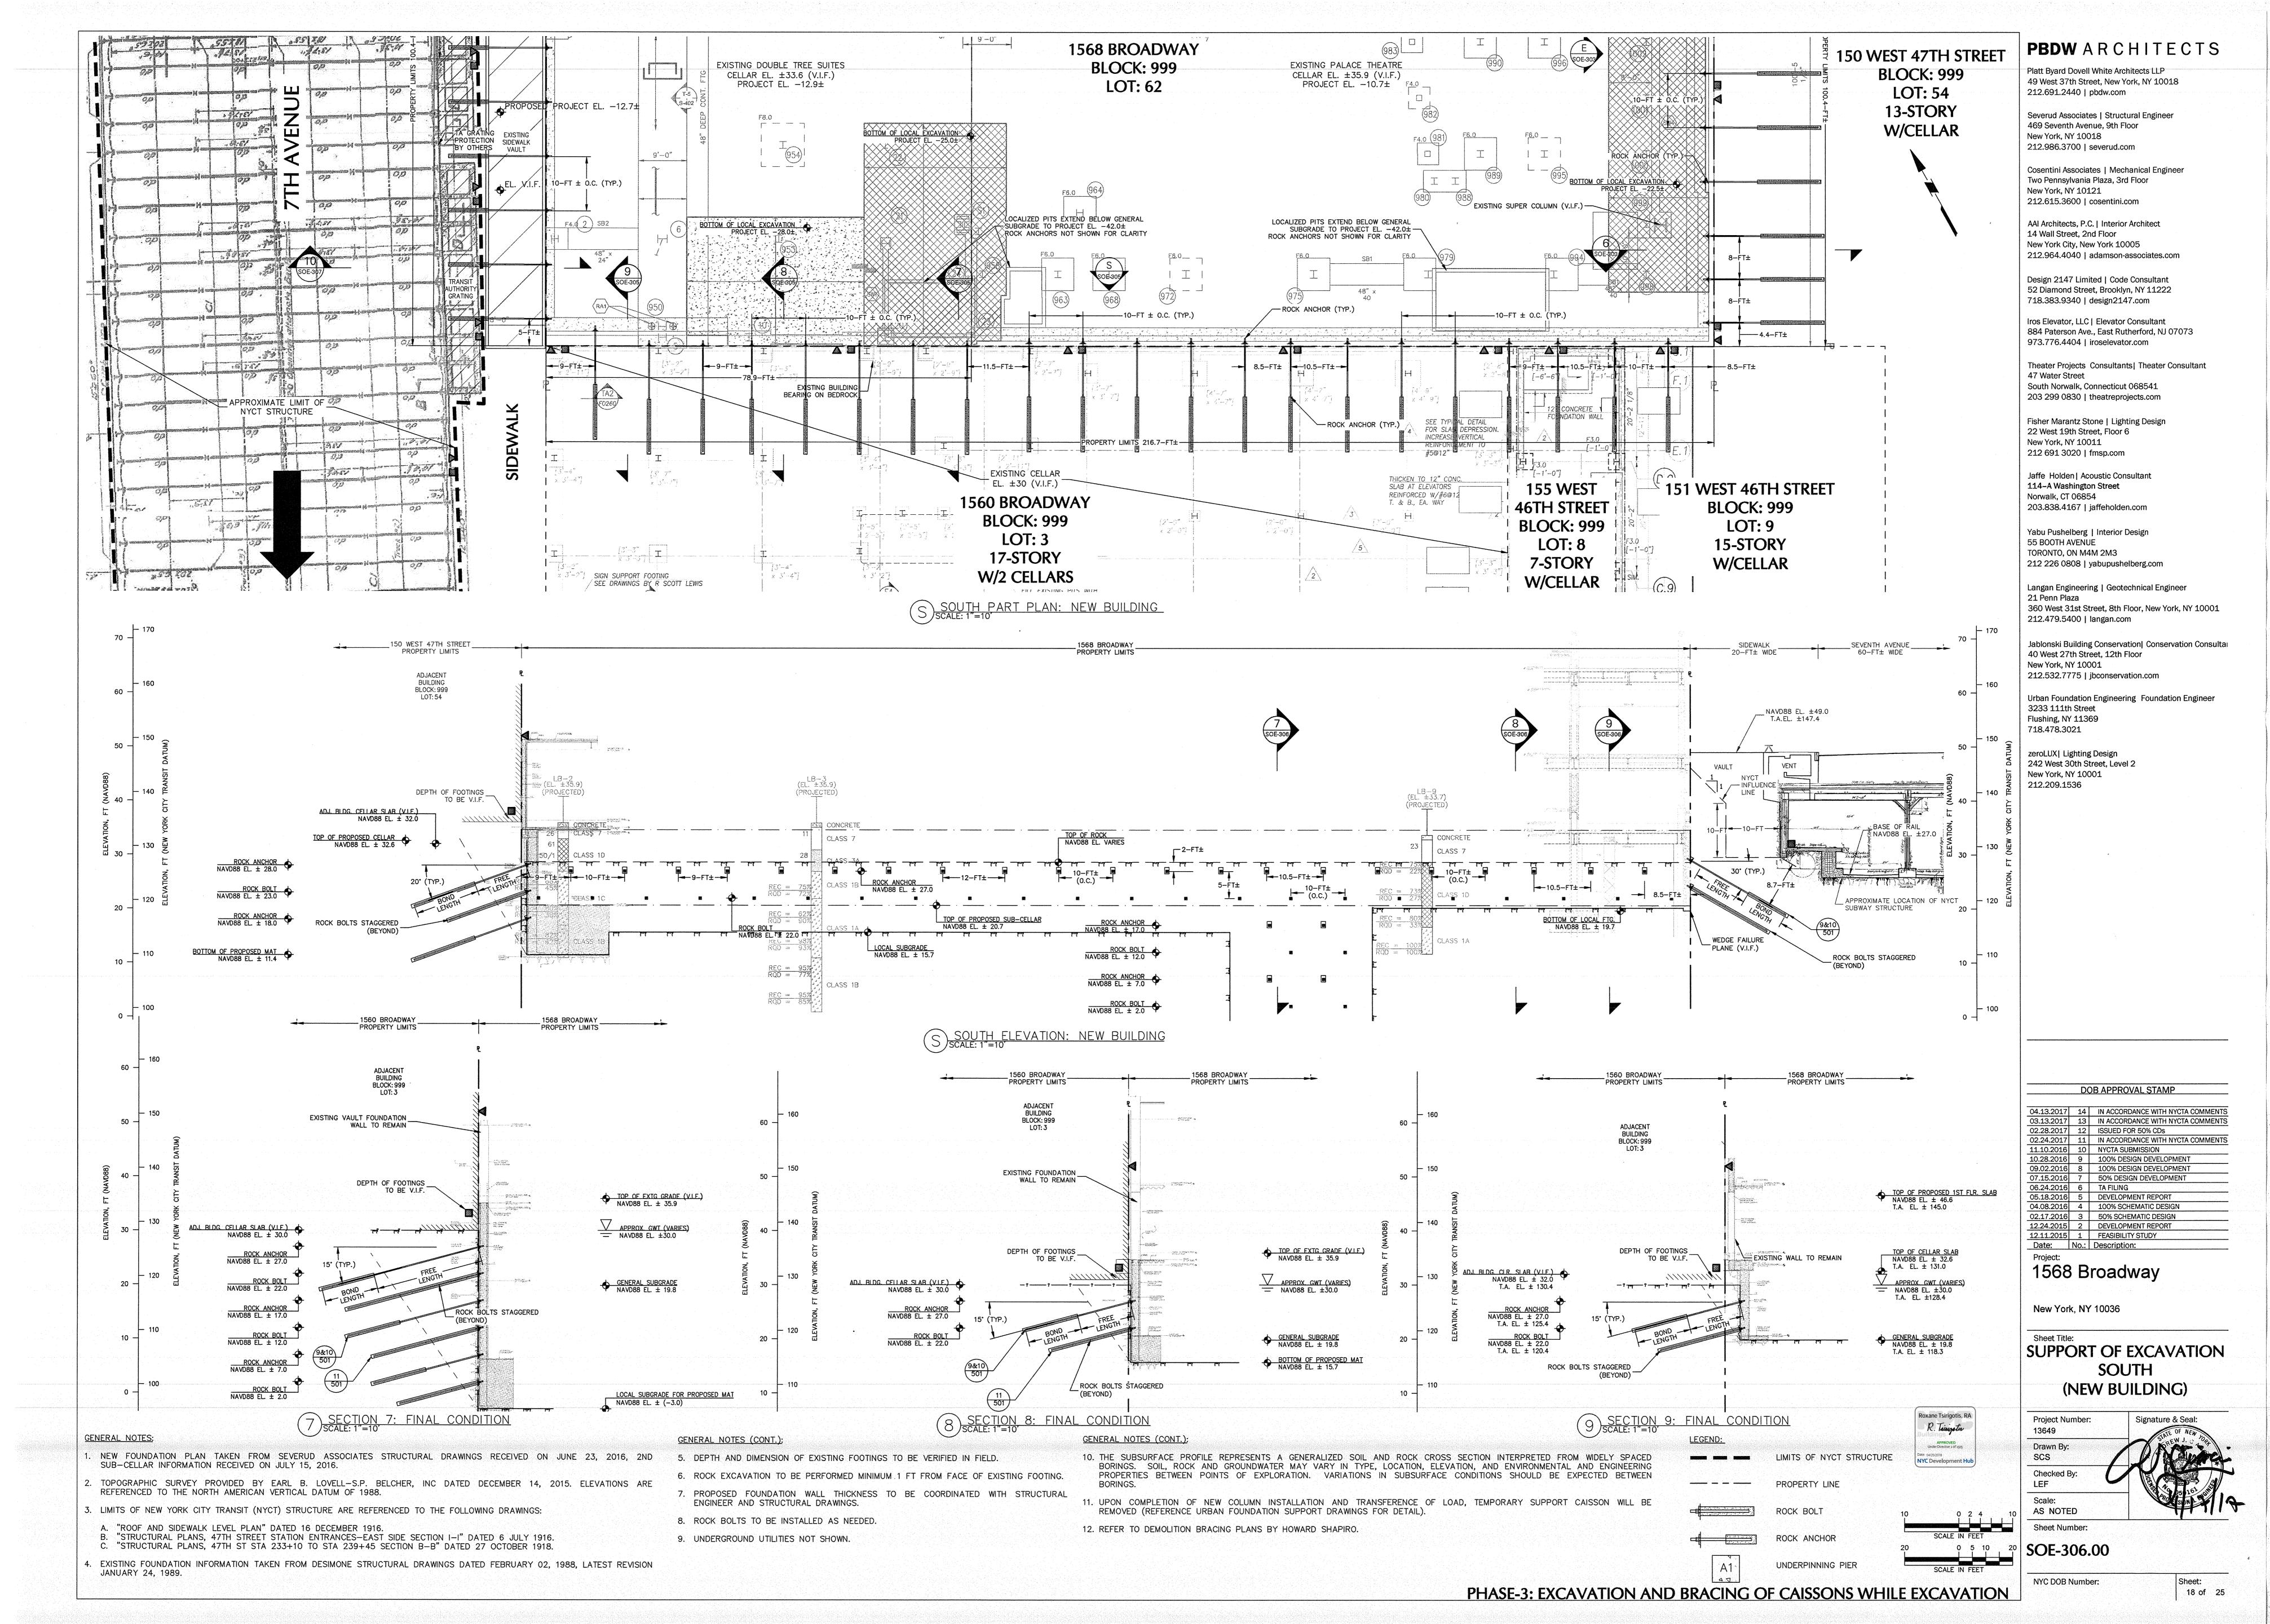
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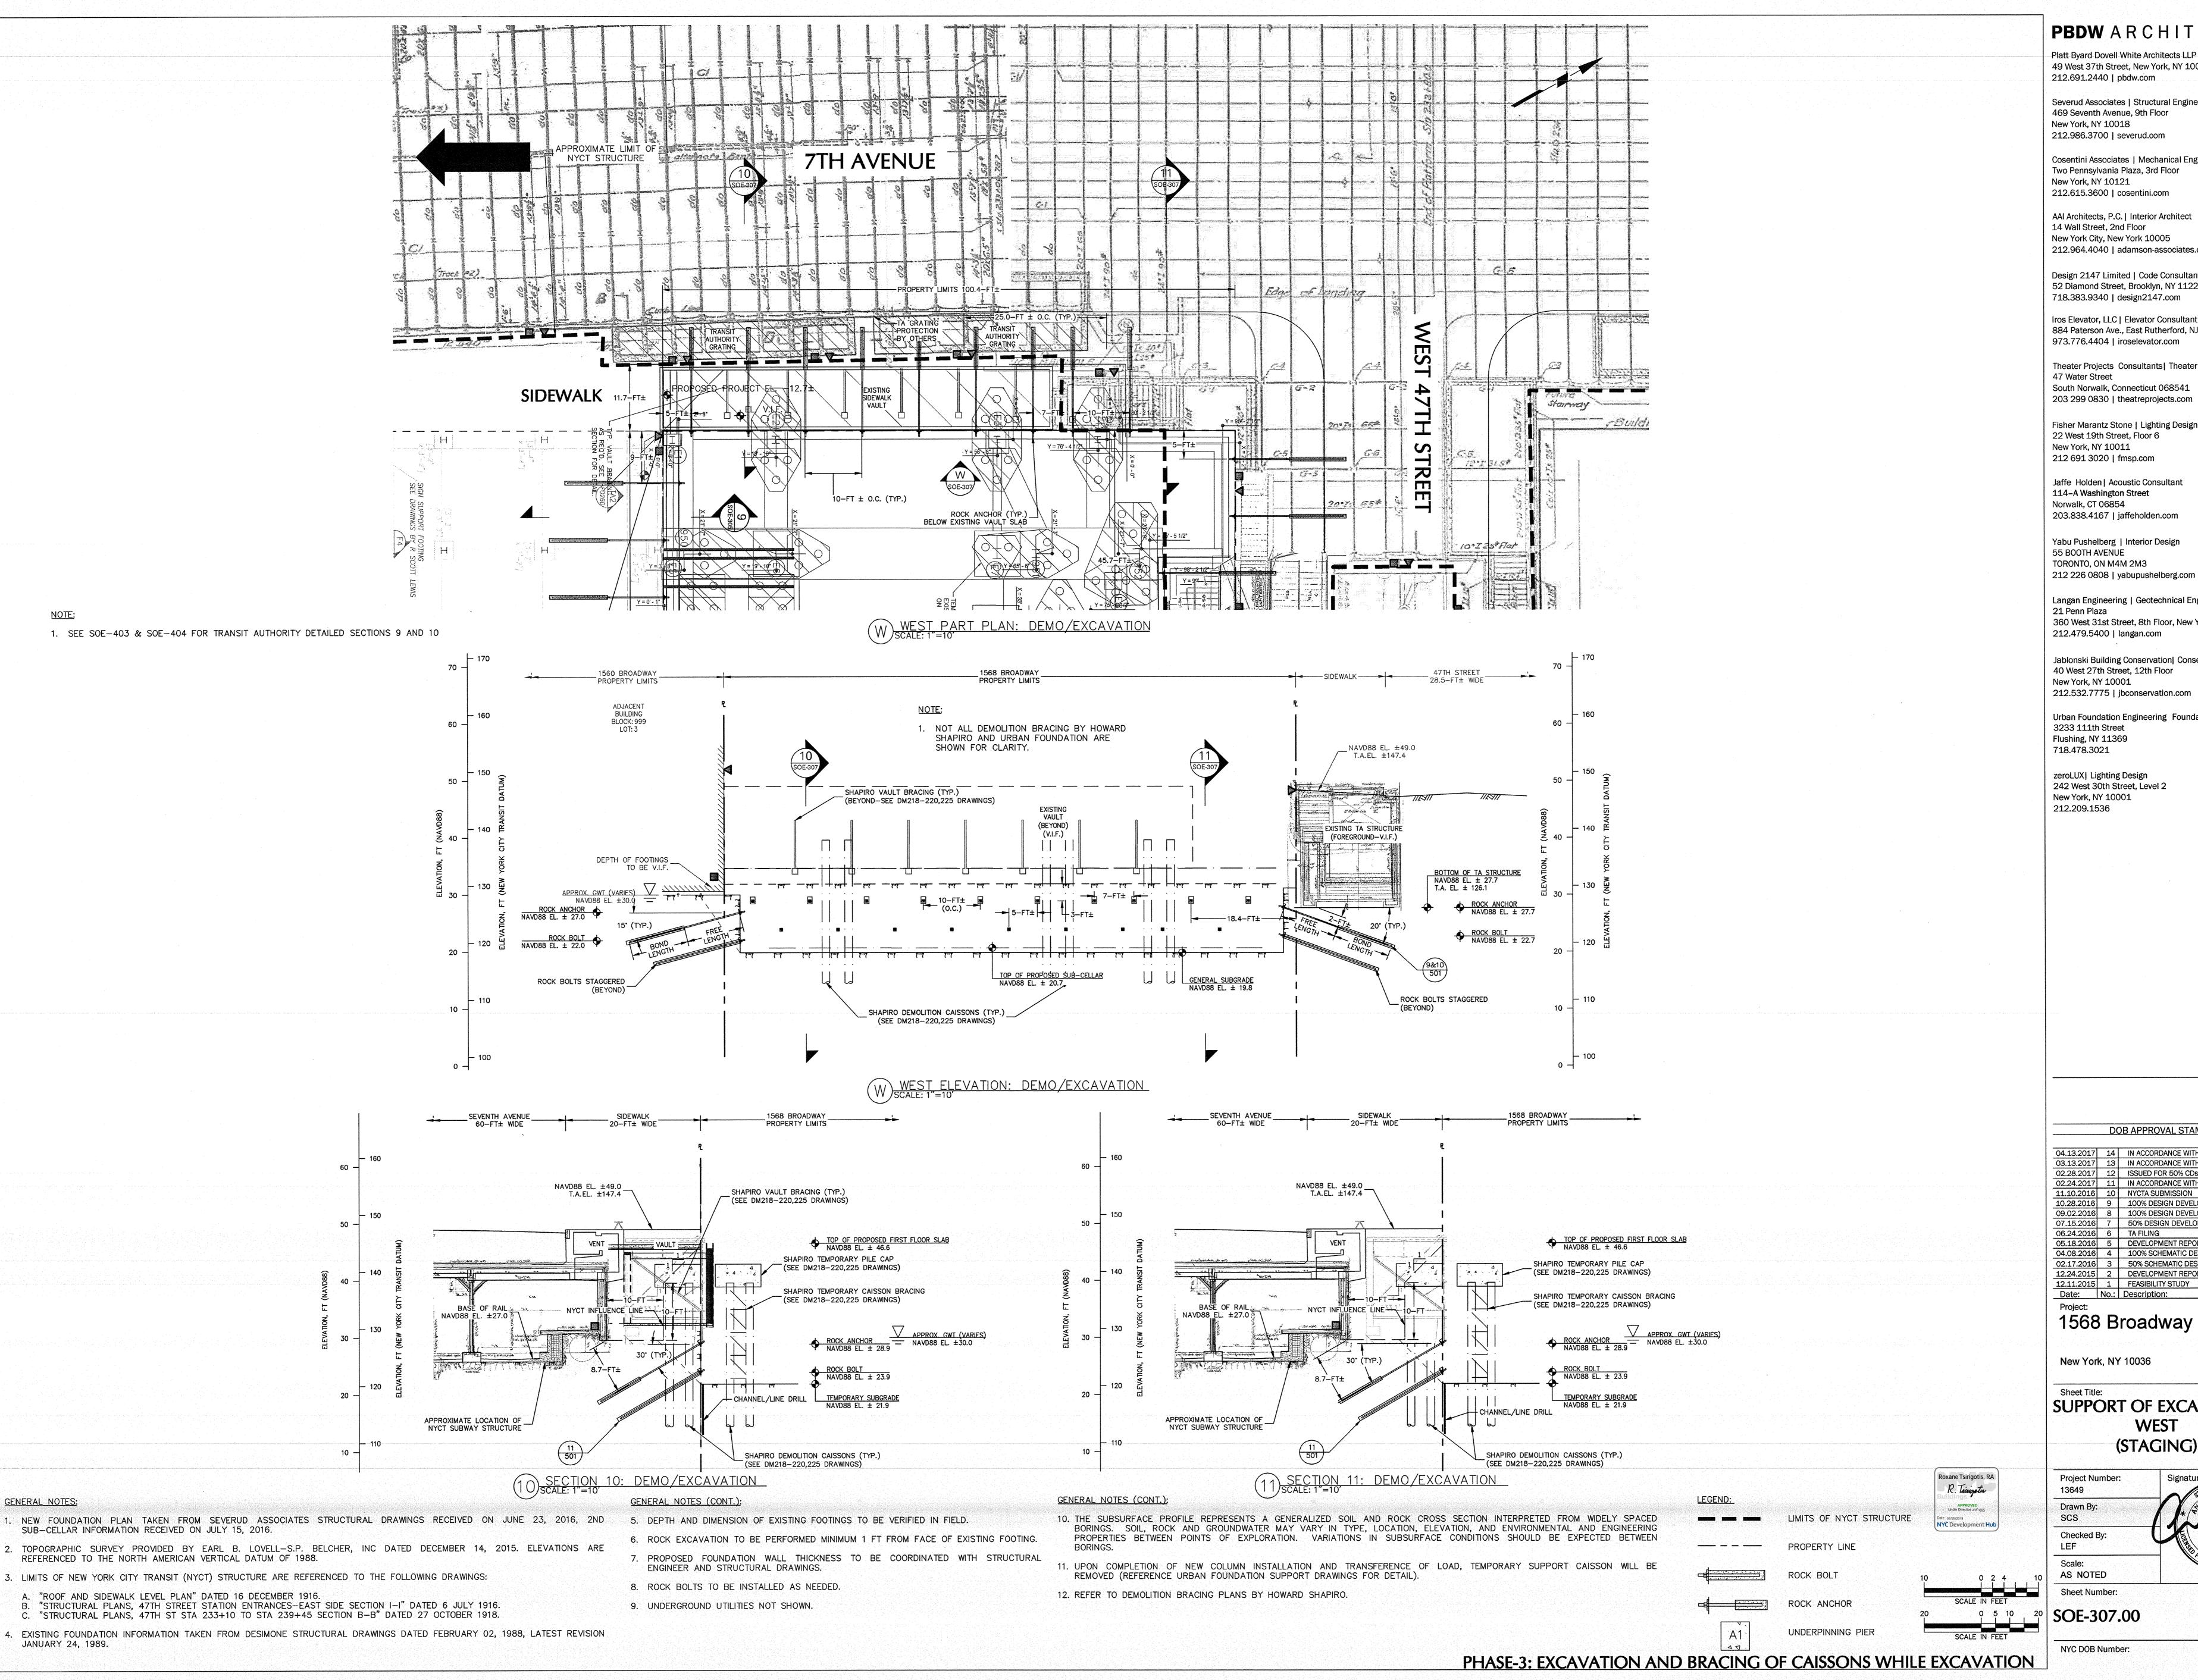
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Sheet: 15 of 25









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New York, NY 10036

SUPPORT OF EXCAVATION

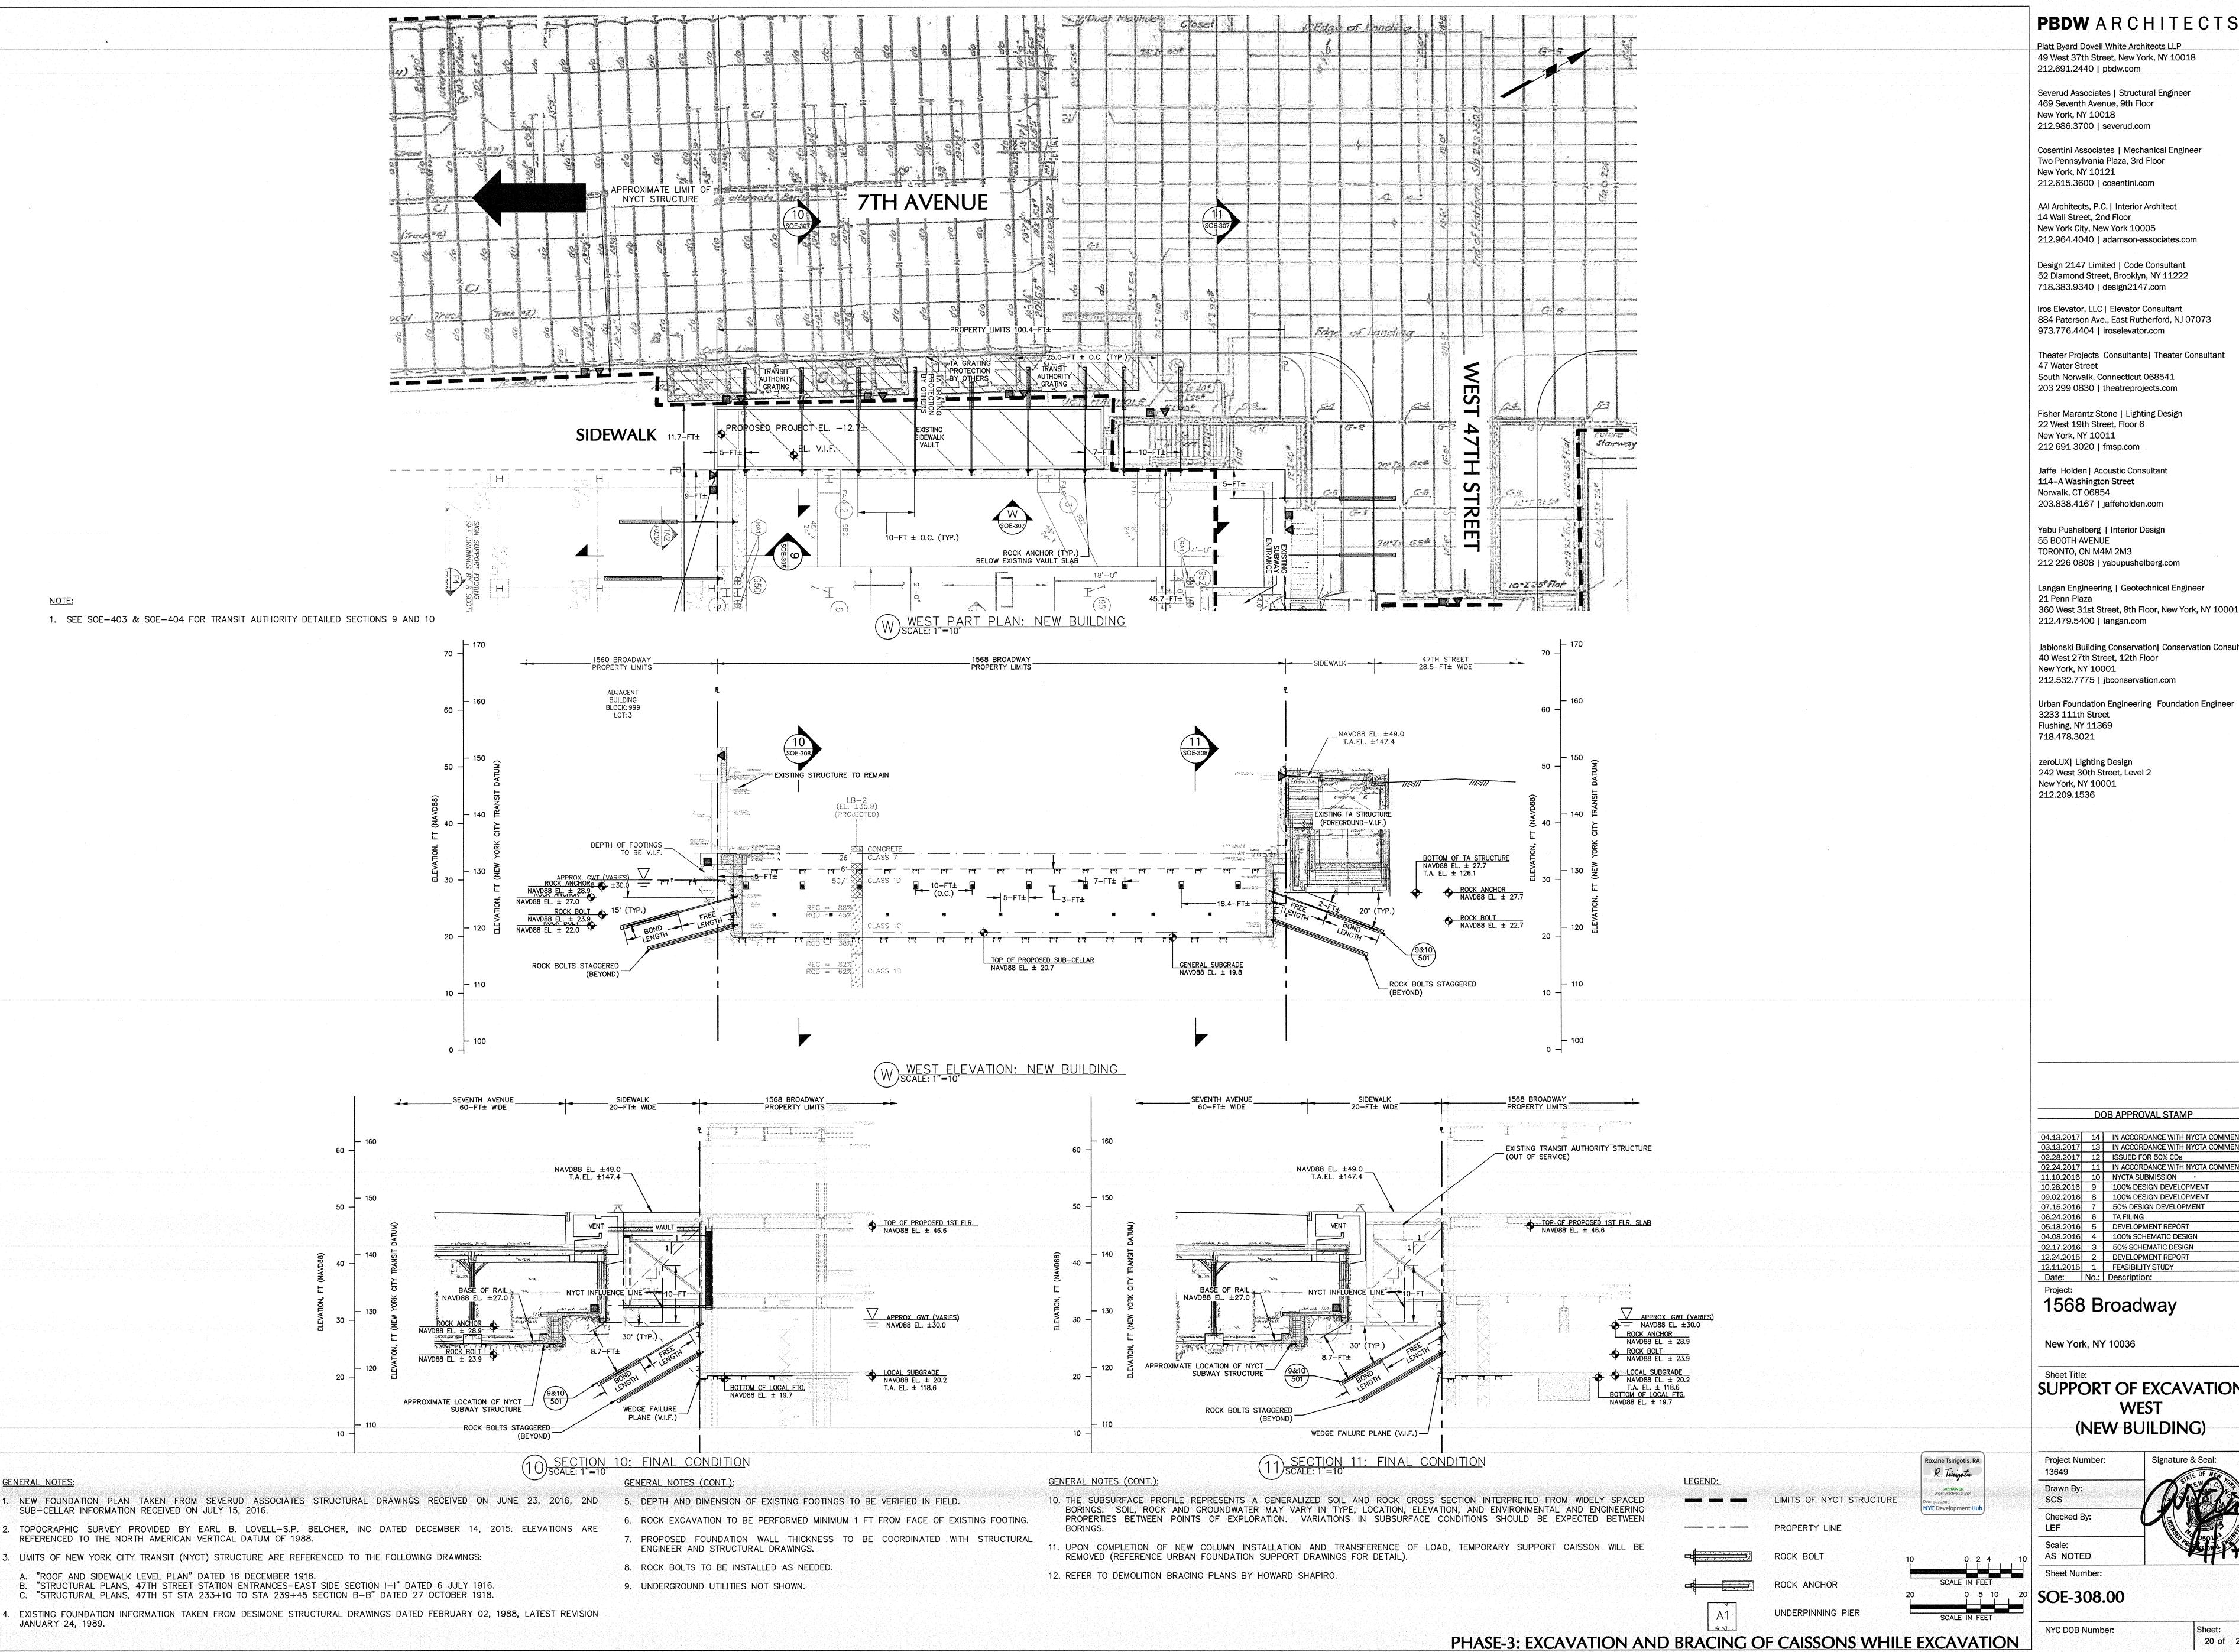
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19 of 25



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SUPPORT OF EXCAVATION WEST (NEW BUILDING)

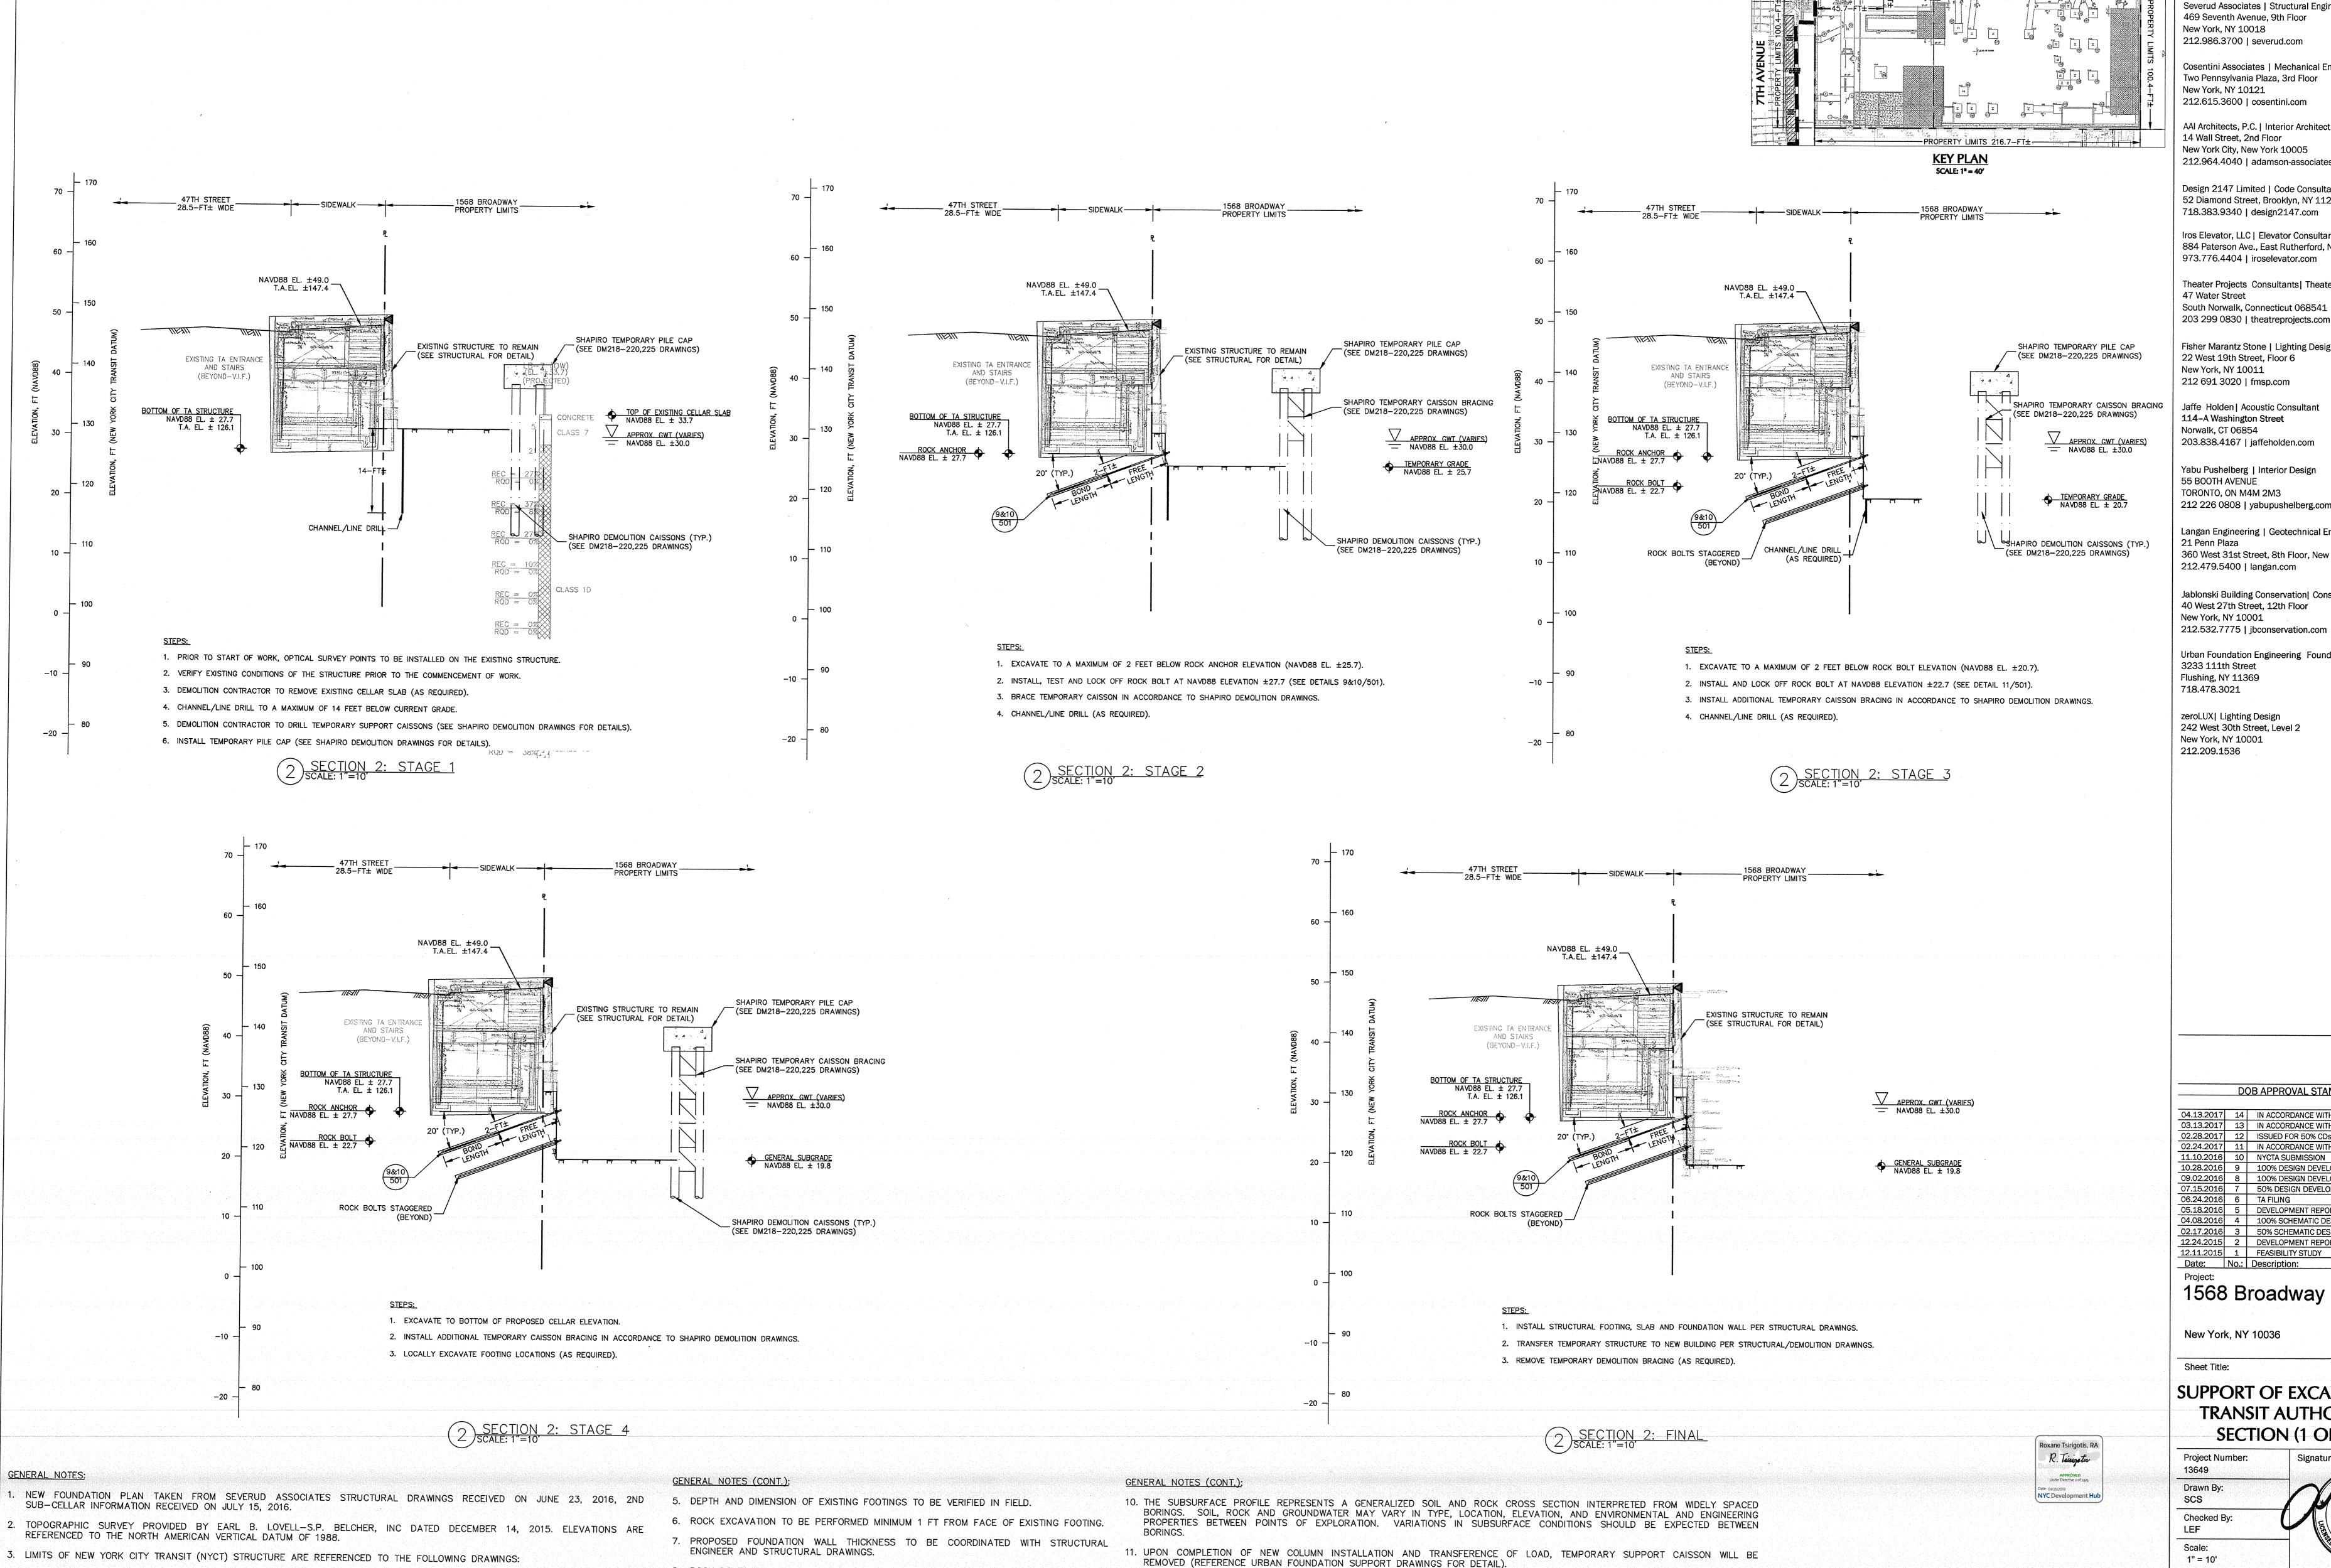
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NYC DOB Number:

20 of 25



8. ROCK BOLTS TO BE INSTALLED AS NEEDED.

9. UNDERGROUND UTILITIES NOT SHOWN.

A. "ROOF AND SIDEWALK LEVEL PLAN" DATED 16 DECEMBER 1916.

JANUARY 24, 1989.

B. "STRUCTURAL PLANS, 47TH STREET STATION ENTRANCES—EAST SIDE SECTION I—I" DATED 6 JULY 1916.
C. "STRUCTURAL PLANS, 47TH ST STA 233+10 TO STA 239+45 SECTION B—B" DATED 27 OCTOBER 1918.

4. EXISTING FOUNDATION INFORMATION TAKEN FROM DESIMONE STRUCTURAL DRAWINGS DATED FEBRUARY 02, 1988, LATEST REVISION

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WEST 47TH STREET

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Sheet Title:

SUPPORT OF EXCAVATION TRANSIT AUTHORITY SECTION (1 OF 4)

Project Number: 13649 Drawn By: SCS Checked By:

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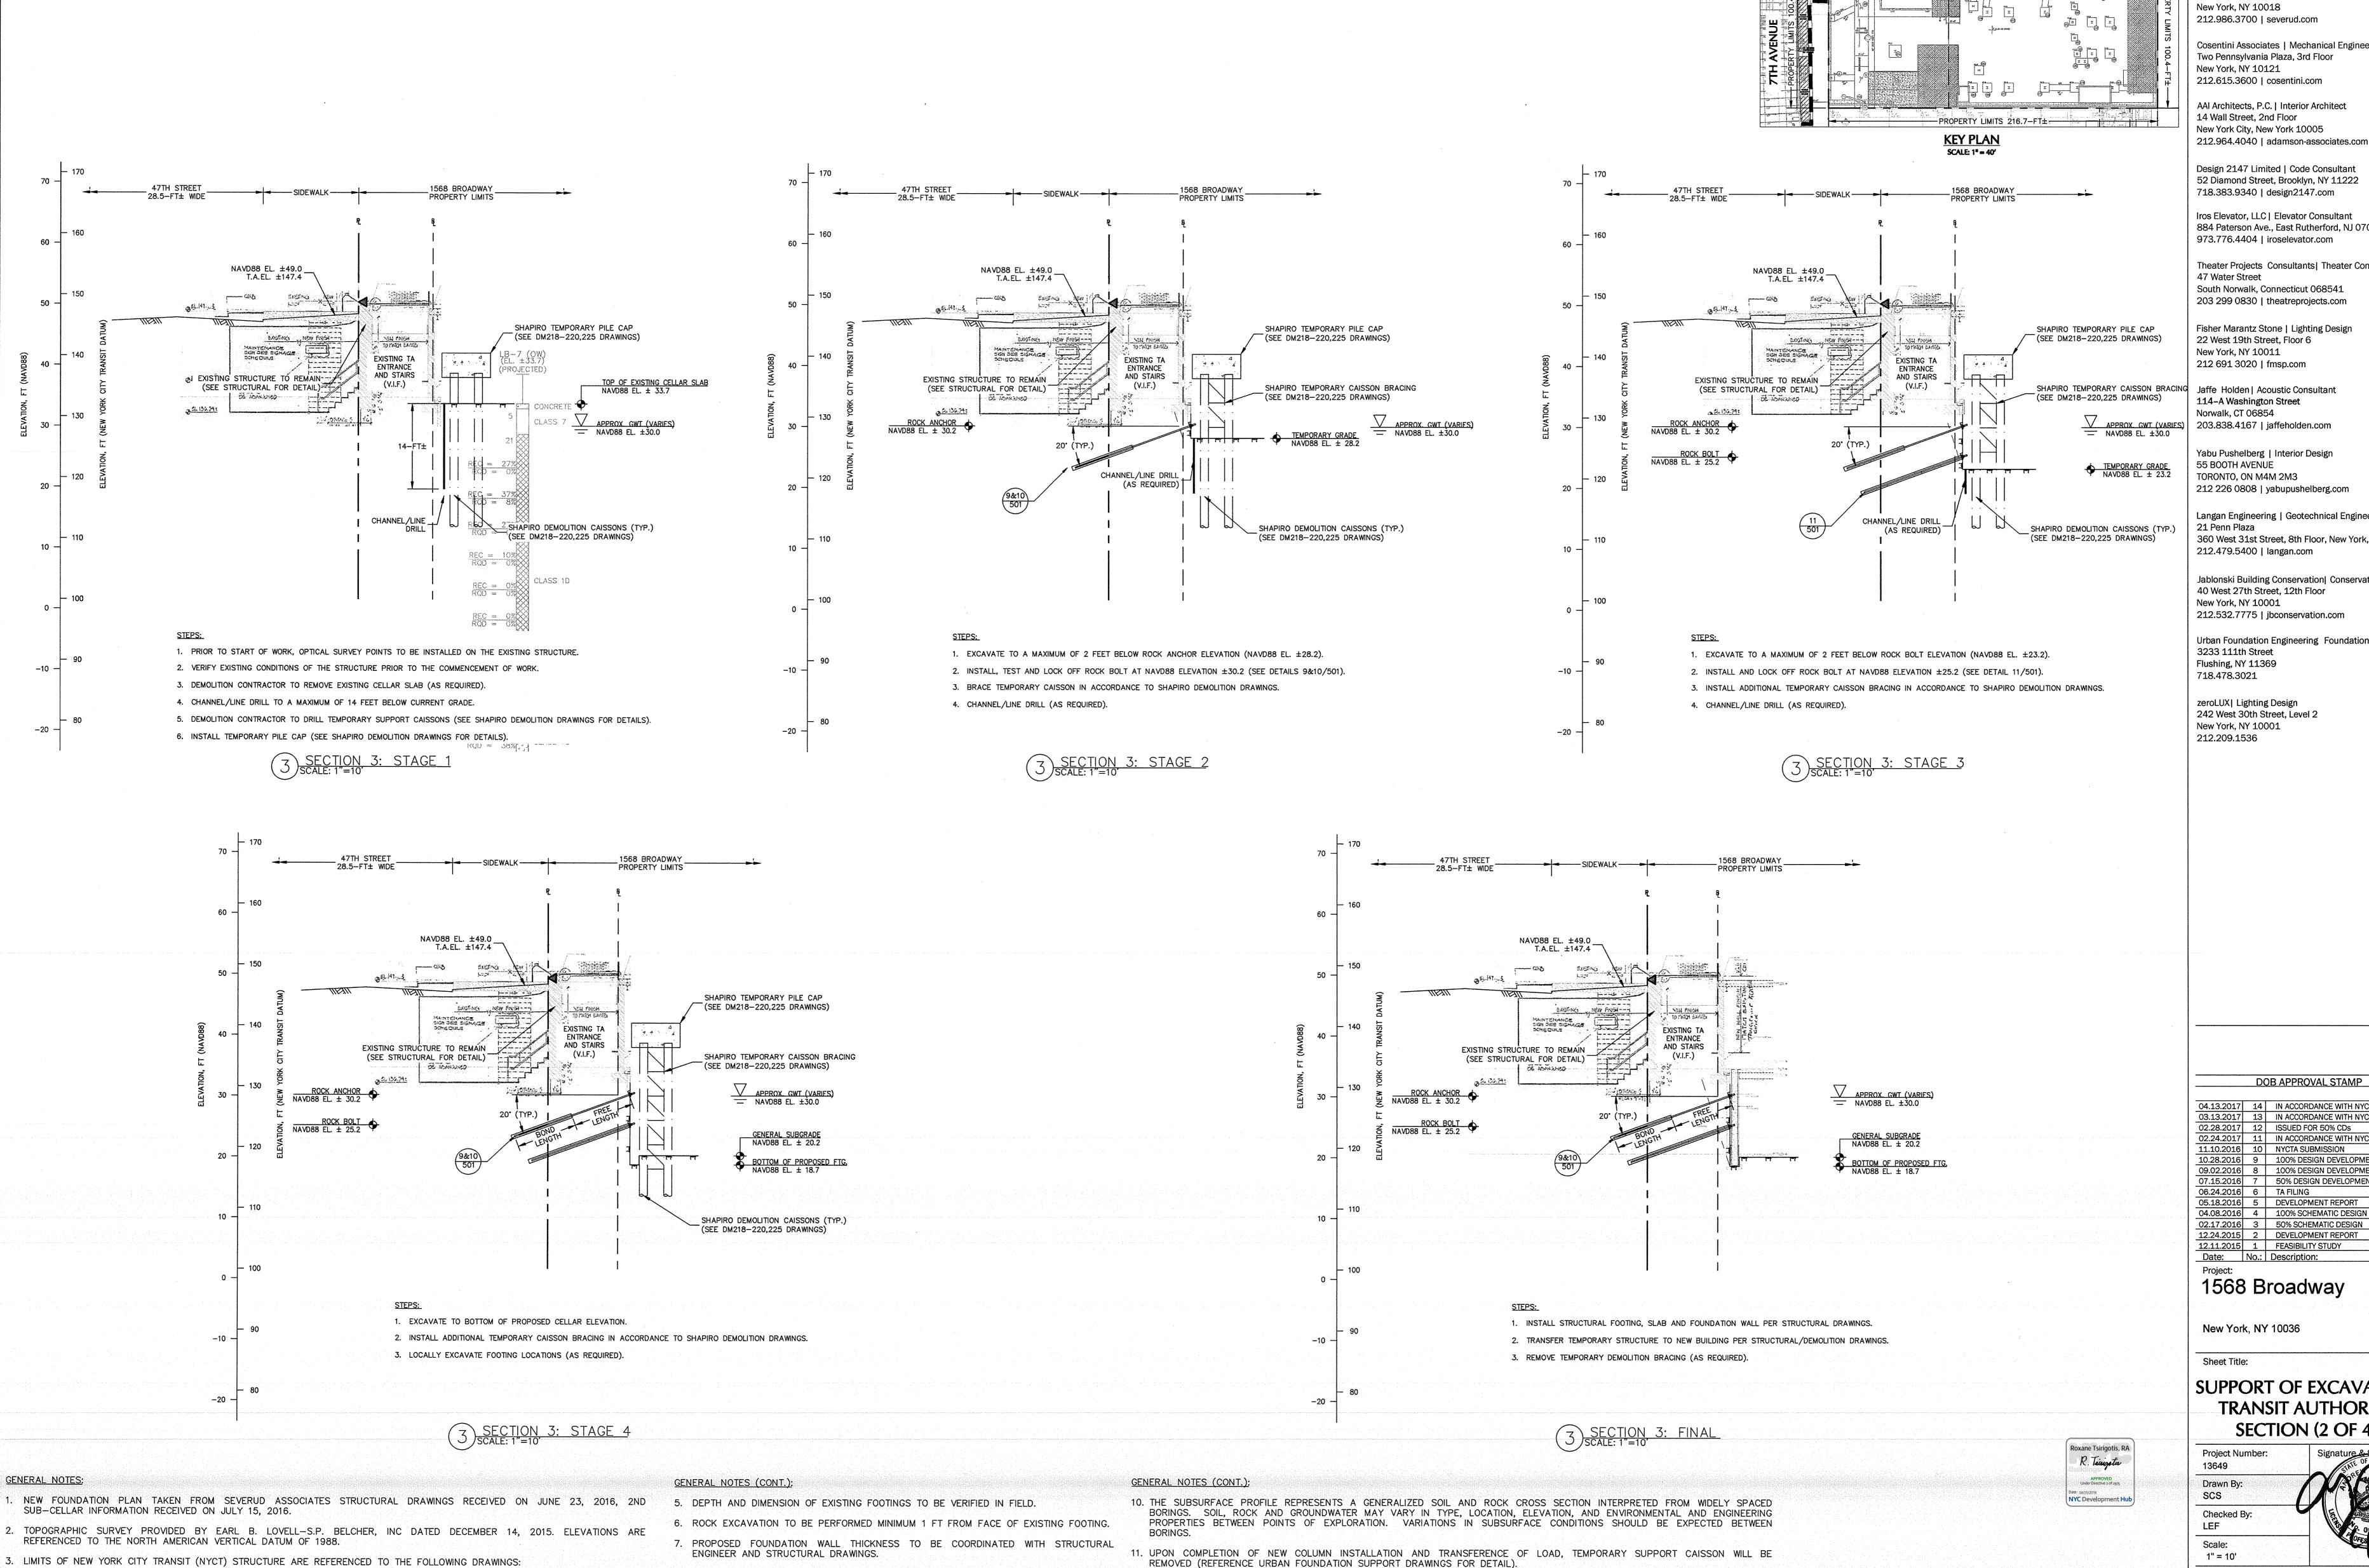
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Signature & Seal:

21 of 25

Sheet Number:

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8. ROCK BOLTS TO BE INSTALLED AS NEEDED.

9. UNDERGROUND UTILITIES NOT SHOWN.

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SUPPORT OF EXCAVATION TRANSIT AUTHORITY SECTION (2 OF 4)

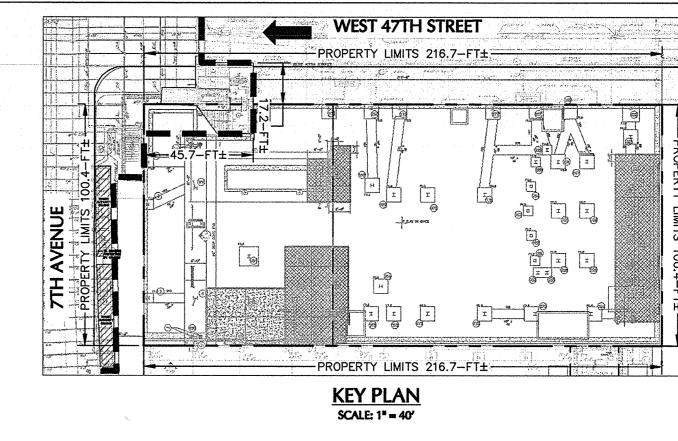
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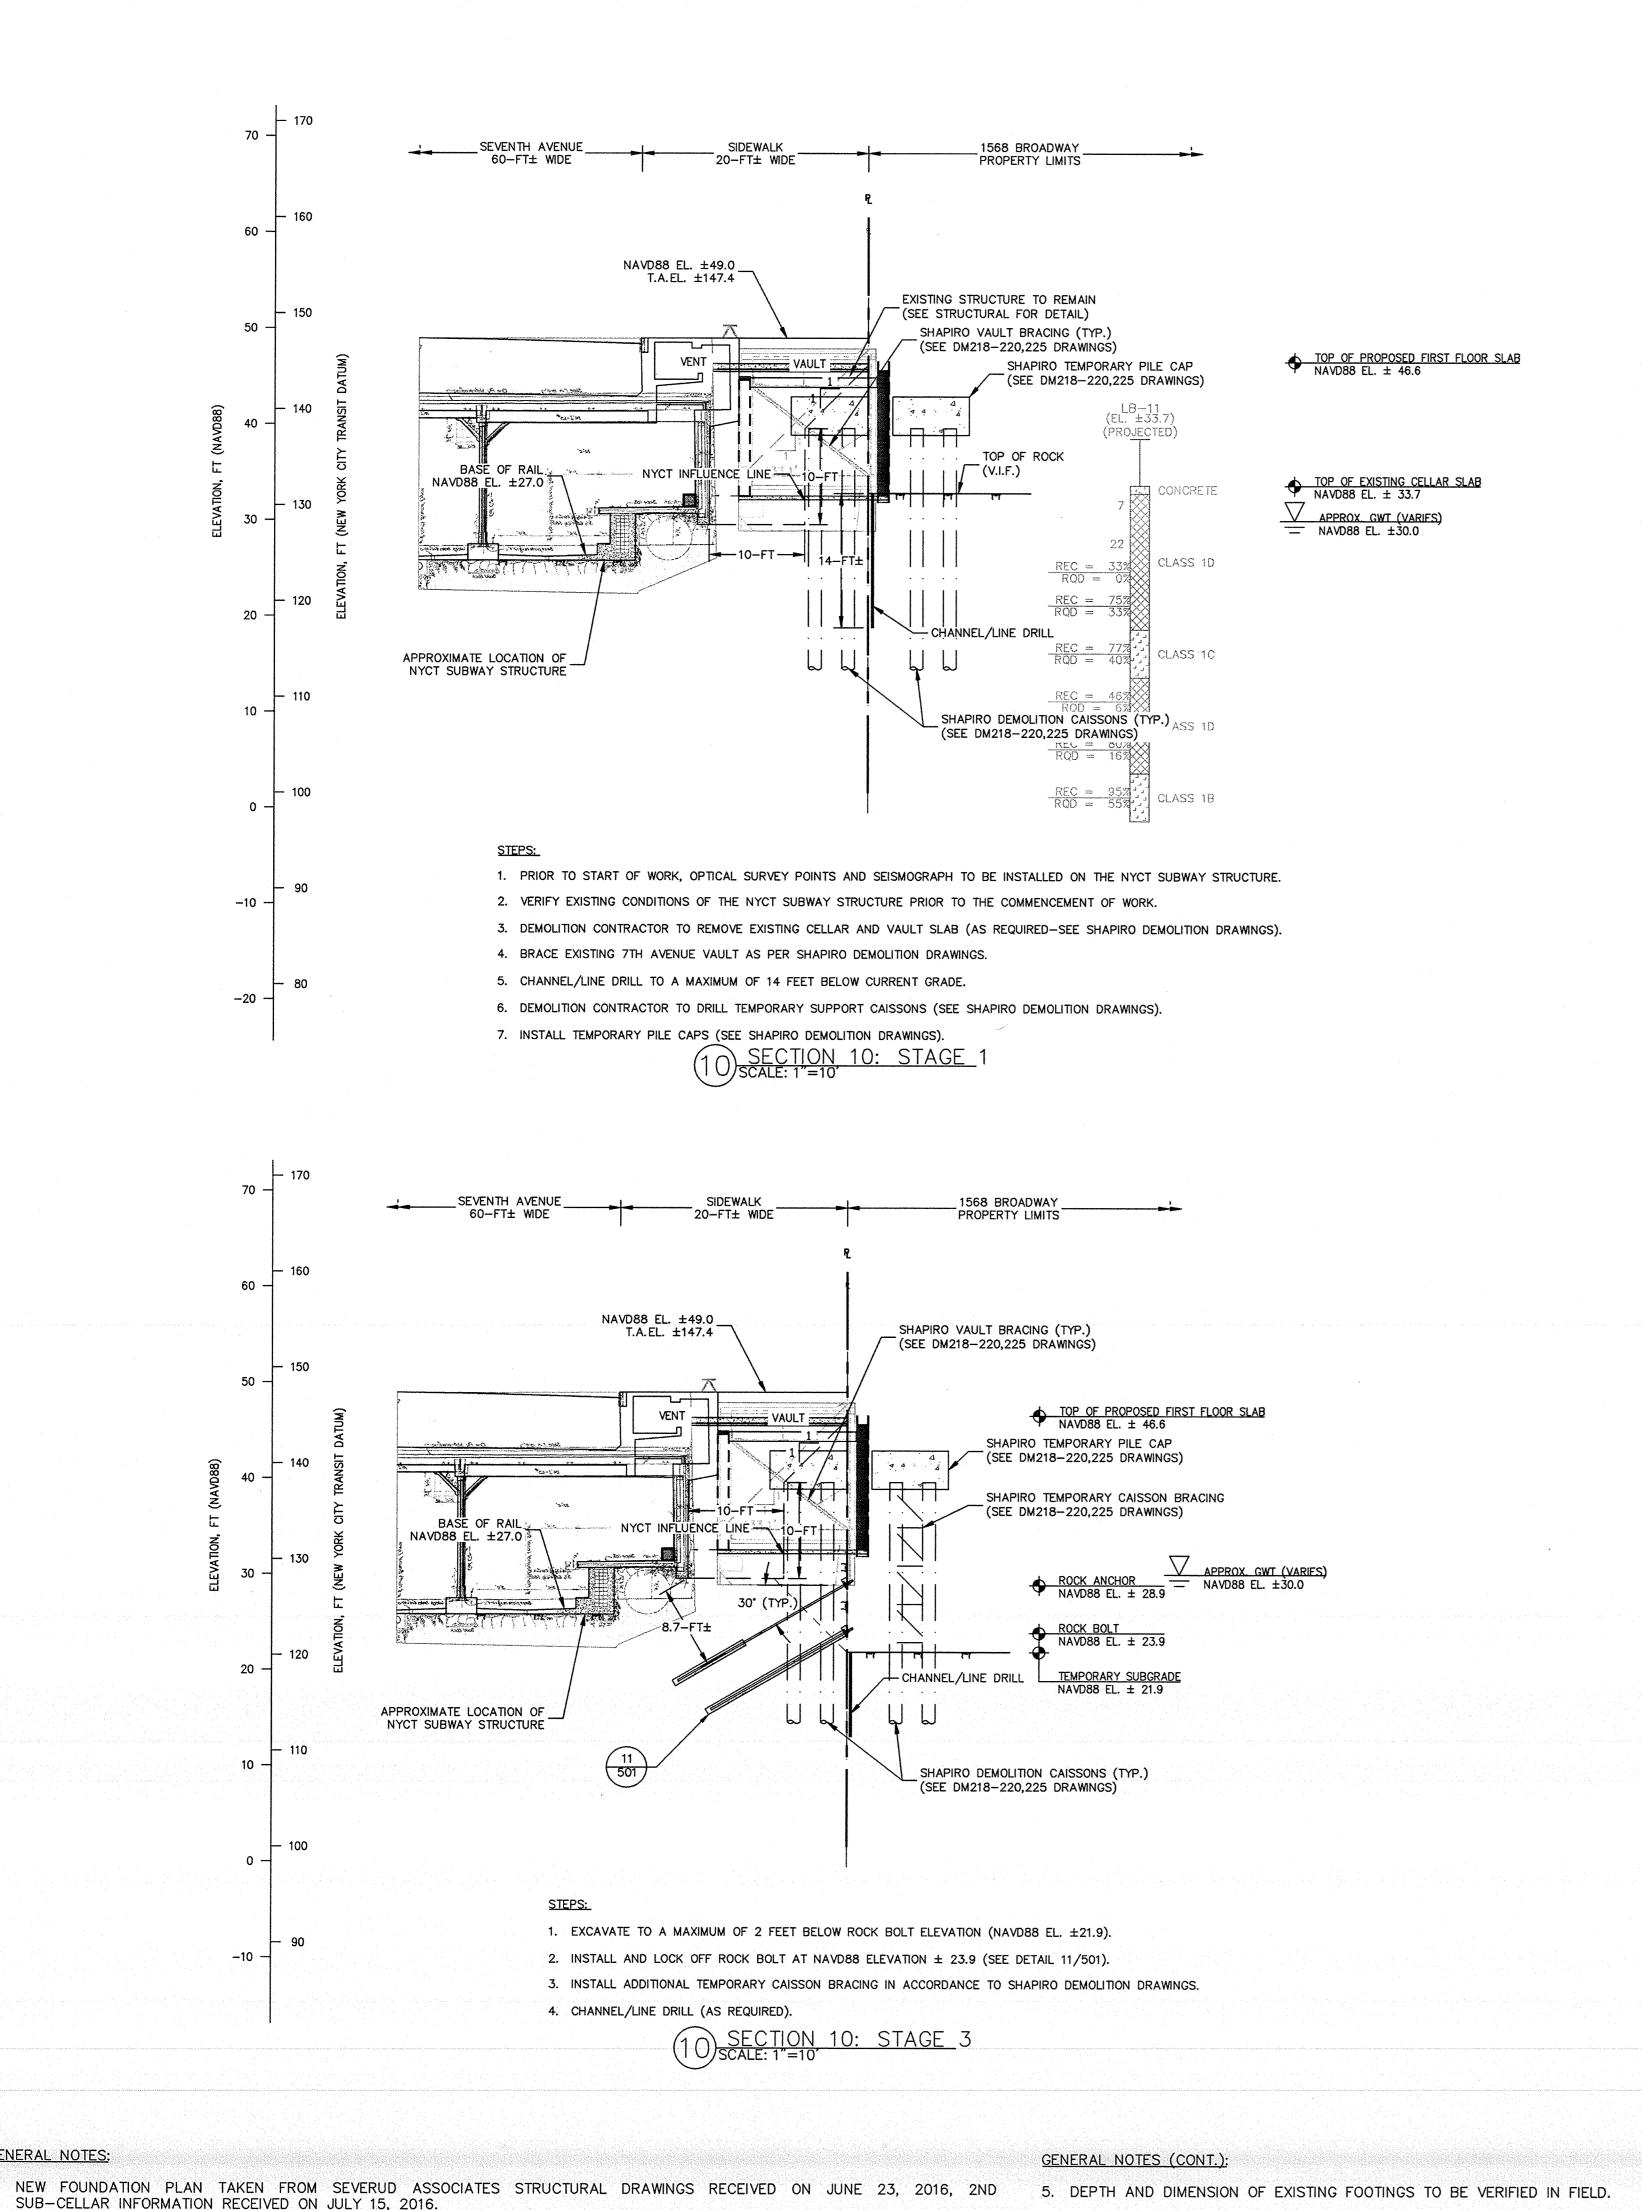
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**GENERAL NOTES:** 

JANUARY 24, 1989.

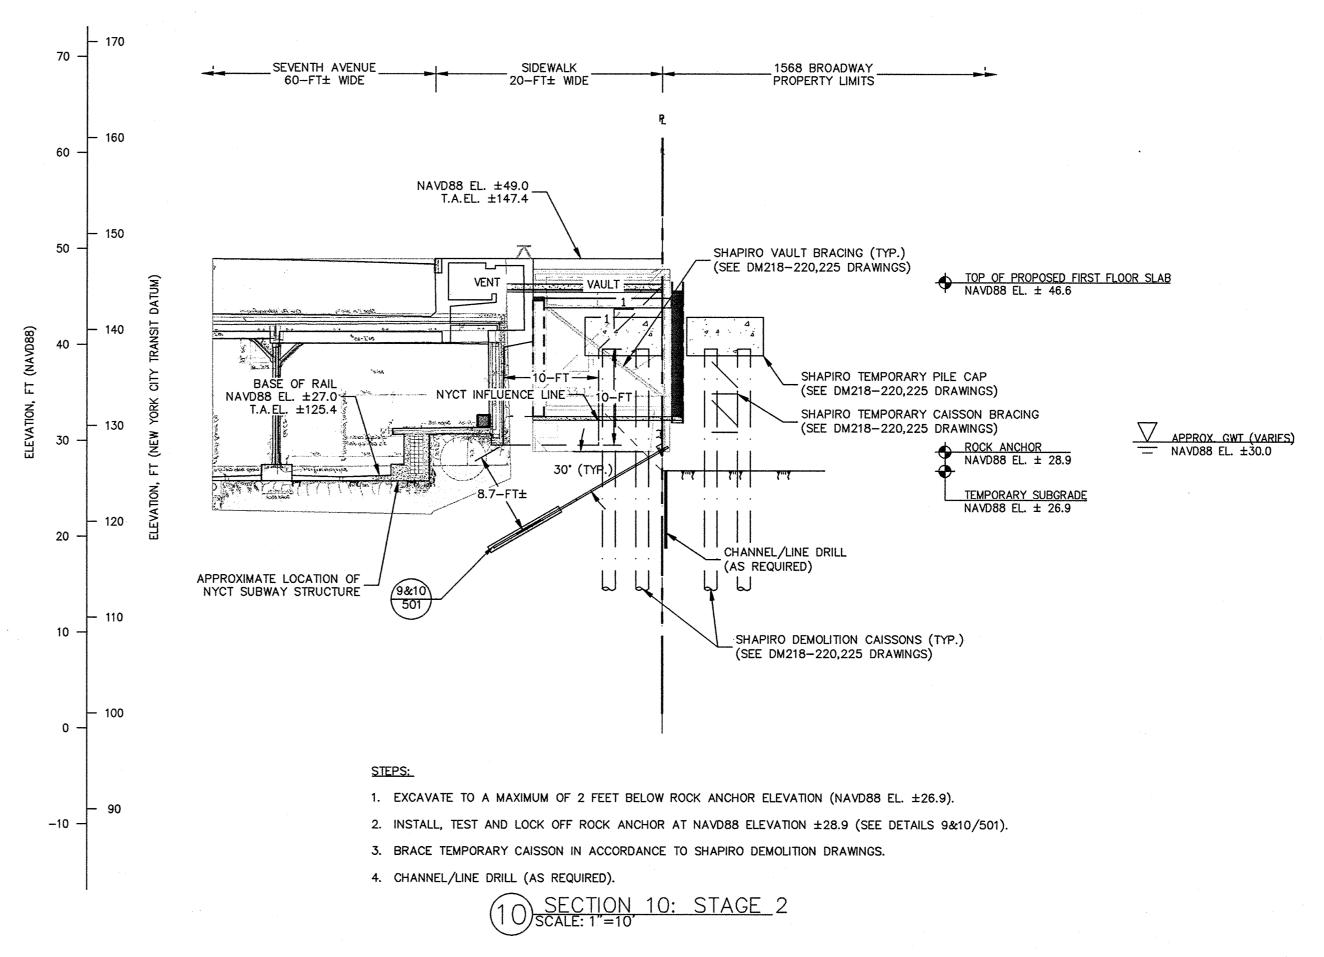
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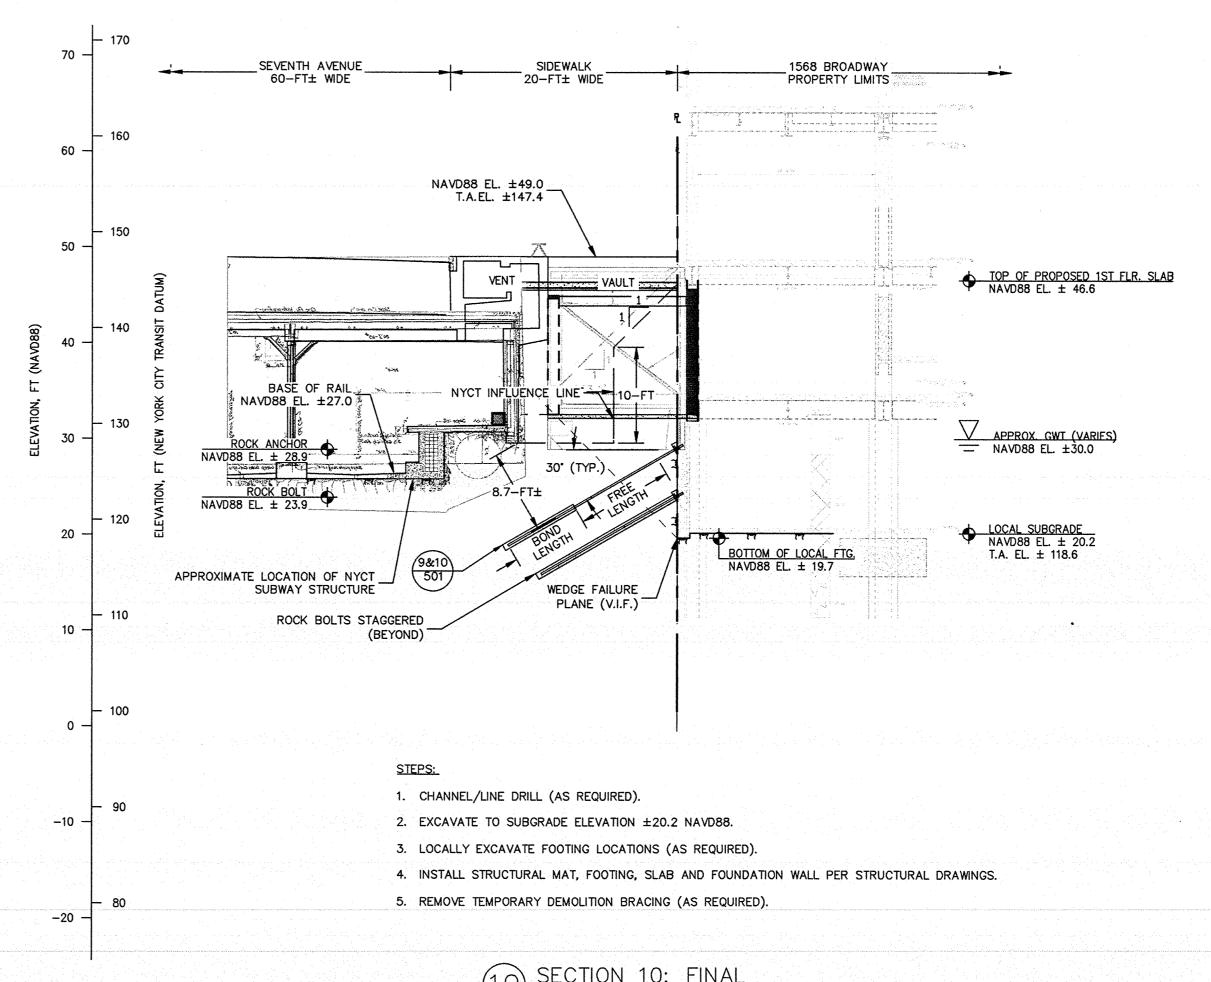
. EXISTING FOUNDATION INFORMATION TAKEN FROM DESIMONE STRUCTURAL DRAWINGS DATED FEBRUARY 02, 1988, LATEST REVISION

LIMITS OF NEW YORK CITY TRANSIT (NYCT) STRUCTURE ARE REFERENCED TO THE FOLLOWING DRAWINGS:

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C. "STRUCTURAL PLANS, 47TH ST STA 233+10 TO STA 239+45 SECTION B-B" DATED 27 OCTOBER 1918.





GENERAL NOTES (CONT.):

6. ROCK EXCAVATION TO BE PERFORMED MINIMUM 1 FT FROM FACE OF EXISTING FOOTING.

7. PROPOSED FOUNDATION WALL THICKNESS TO BE COORDINATED WITH STRUCTURAL

ENGINEER AND STRUCTURAL DRAWINGS.

8. ROCK BOLTS TO BE INSTALLED AS NEEDED.

9. UNDERGROUND UTILITIES NOT SHOWN.

10. THE SUBSURFACE PROFILE REPRESENTS A GENERALIZED SOIL AND ROCK CROSS SECTION INTERPRETED FROM WIDELY SPACED BORINGS. SOIL, ROCK AND GROUNDWATER MAY VARY IN TYPE, LOCATION, ELEVATION, AND ENVIRONMENTAL AND ENGINEERING PROPERTIES BETWEEN POINTS OF EXPLORATION. VARIATIONS IN SUBSURFACE CONDITIONS SHOULD BE EXPECTED BETWEEN

11. UPON COMPLETION OF NEW COLUMN INSTALLATION AND TRANSFERENCE OF LOAD, TEMPORARY SUPPORT CAISSON WILL BE REMOVED (REFERENCE URBAN FOUNDATION SUPPORT DRAWINGS FOR DETAIL). 12. REFER TO DEMOLITION BRACING PLANS BY HOWARD SHAPIRO.

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	02.17.2016	3	50% SCHEMATIC DESIGN
	12.24.2015	2	DEVELOPMENT REPORT
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SUPPORT OF EXCAVATION TRANSIT AUTHORITY SECTION (3 OF 4)

23 of 25

Project Number: Drawn By: SCS

Roxane Tsirigotis, RA

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NYC Development Hub

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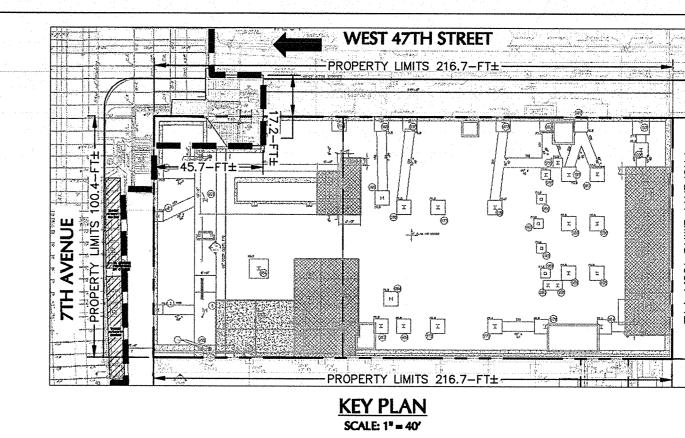
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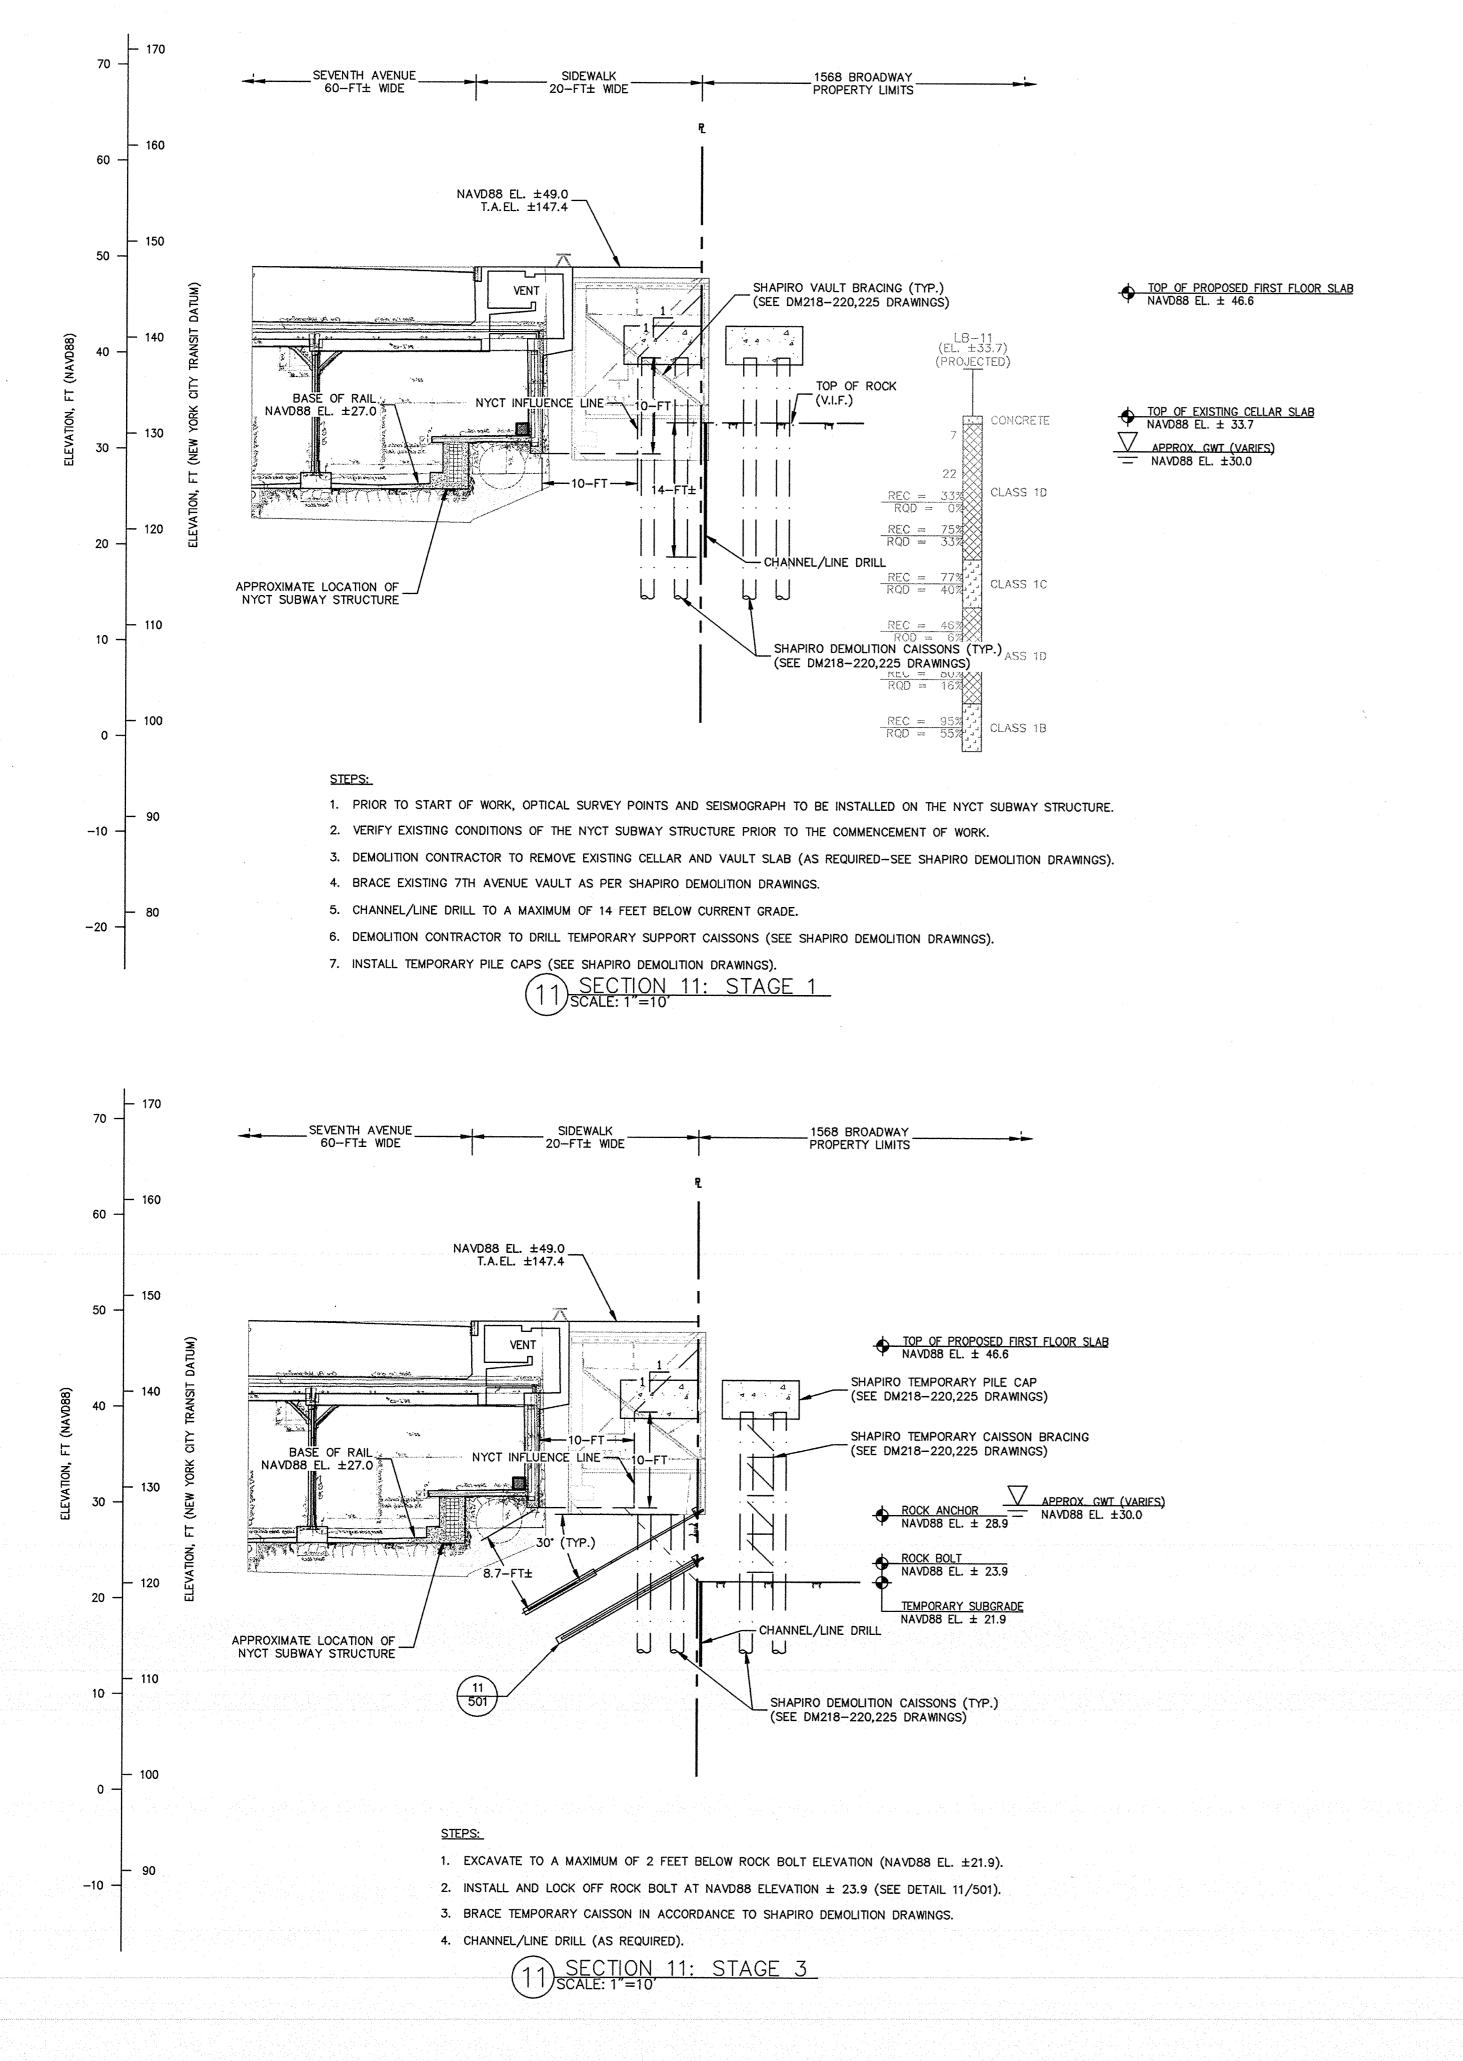
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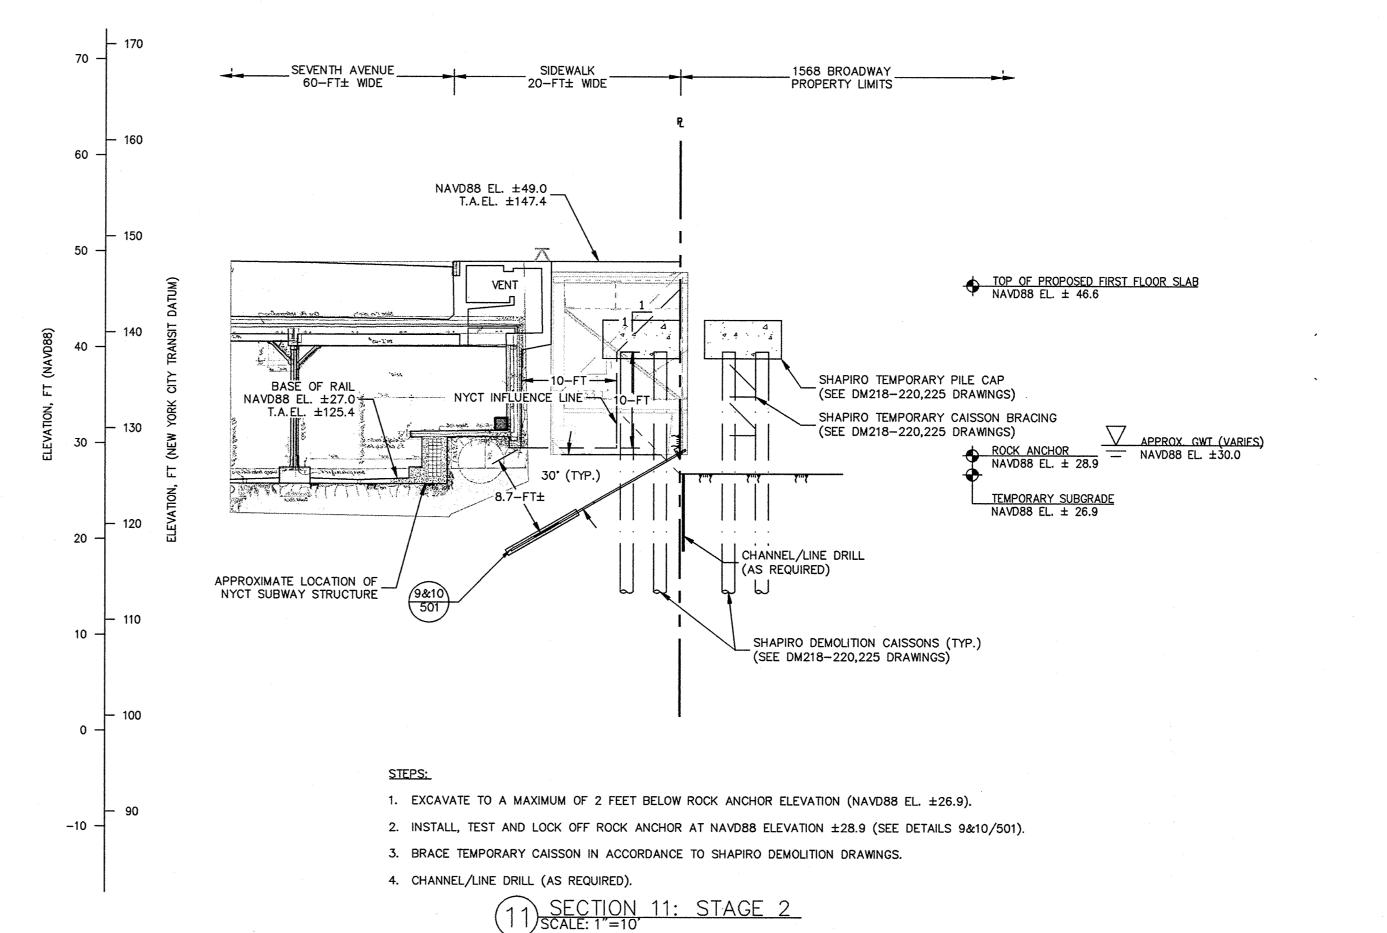
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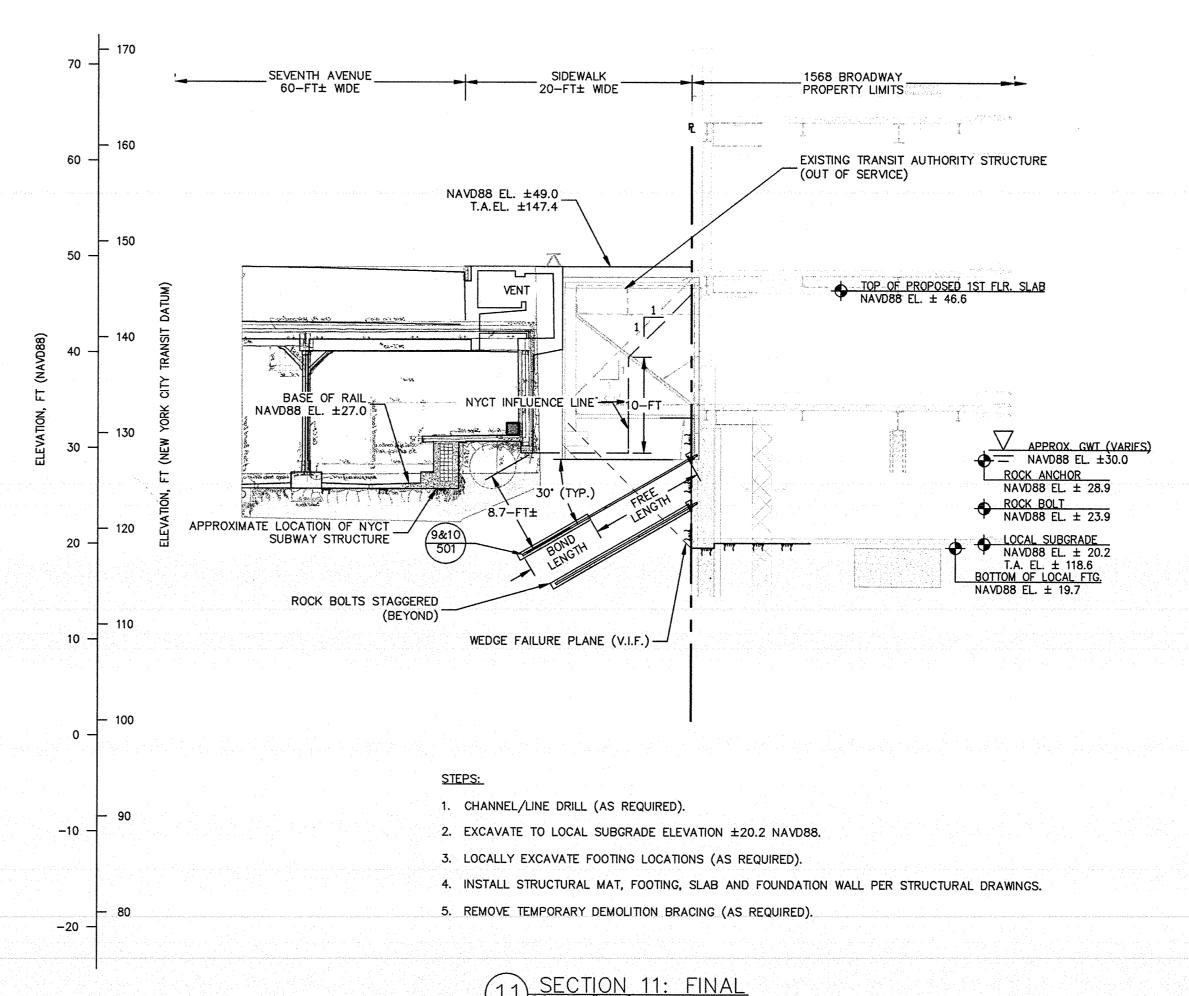
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PHASE-3: EXCAVATION AND BRACING OF CAISSONS WHILE EXCAVATION









**GENERAL NOTES:** 

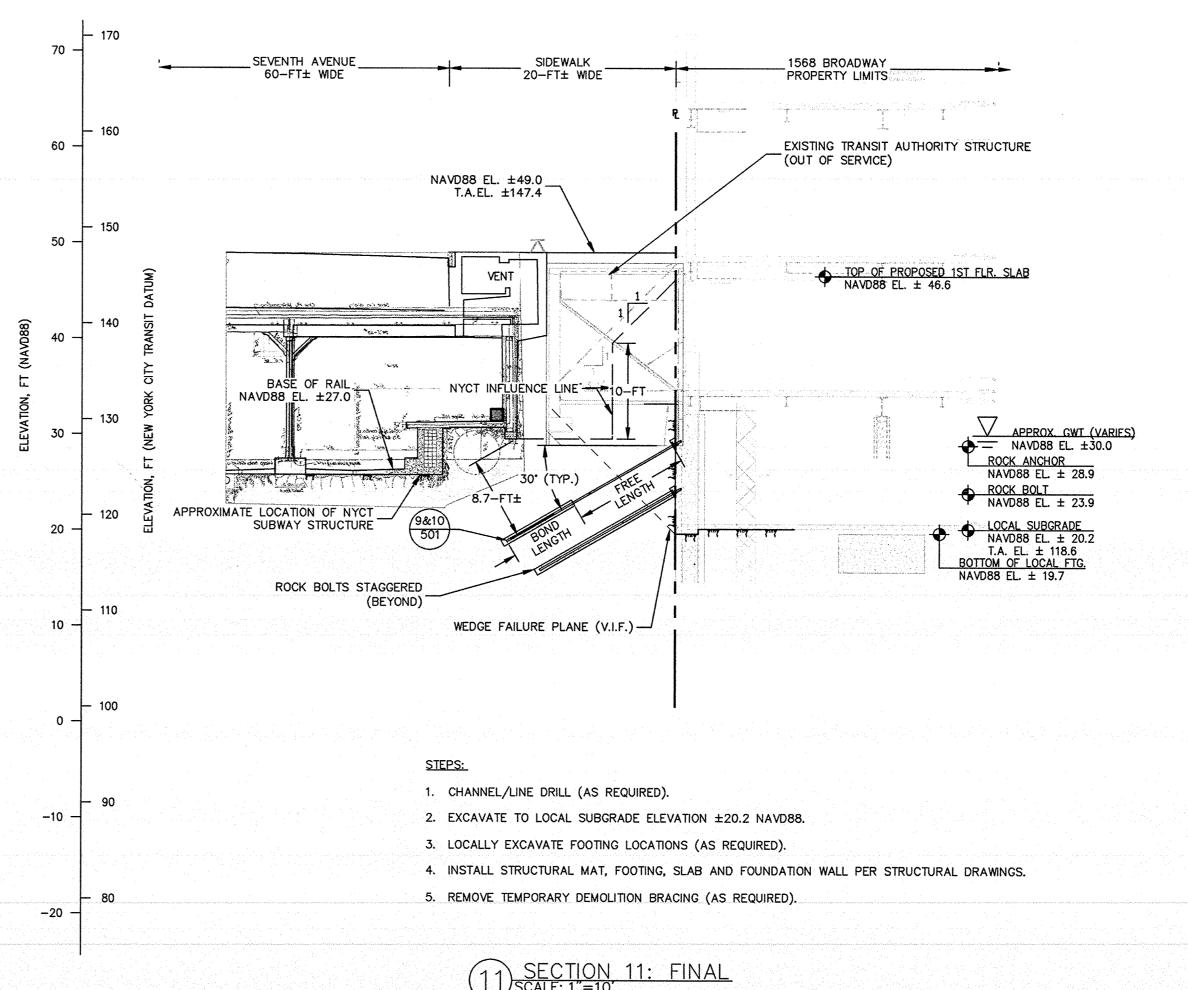
- NEW FOUNDATION PLAN TAKEN FROM SEVERUD ASSOCIATES STRUCTURAL DRAWINGS RECEIVED ON JUNE 23, 2016, 2ND SUB-CELLAR INFORMATION RECEIVED ON JULY 15, 2016.
- TOPOGRAPHIC SURVEY PROVIDED BY EARL B. LOVELL-S.P. BELCHER, INC DATED DECEMBER 14, 2015. ELEVATIONS ARE REFERENCED TO THE NORTH AMERICAN VERTICAL DATUM OF 1988.
- 3. LIMITS OF NEW YORK CITY TRANSIT (NYCT) STRUCTURE ARE REFERENCED TO THE FOLLOWING DRAWINGS:
- A. "ROOF AND SIDEWALK LEVEL PLAN" DATED 16 DECEMBER 1916.

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- EXISTING FOUNDATION INFORMATION TAKEN FROM DESIMONE STRUCTURAL DRAWINGS DATED FEBRUARY 02, 1988, LATEST REVISION JANUARY 24, 1989.

**GENERAL NOTES (CONT.):** 

- 5. DEPTH AND DIMENSION OF EXISTING FOOTINGS TO BE VERIFIED IN FIELD.
- 6. ROCK EXCAVATION TO BE PERFORMED MINIMUM 1 FT FROM FACE OF EXISTING FOOTING.
- 7. PROPOSED FOUNDATION WALL THICKNESS TO BE COORDINATED WITH STRUCTURAL ENGINEER AND STRUCTURAL DRAWINGS.
- 8. ROCK BOLTS TO BE INSTALLED AS NEEDED.
- 9. UNDERGROUND UTILITIES NOT SHOWN.



GENERAL NOTES (CONT.):

- 10. THE SUBSURFACE PROFILE REPRESENTS A GENERALIZED SOIL AND ROCK CROSS SECTION INTERPRETED FROM WIDELY SPACED BORINGS. SOIL, ROCK AND GROUNDWATER MAY VARY IN TYPE, LOCATION, ELEVATION, AND ENVIRONMENTAL AND ENGINEERING PROPERTIES BETWEEN POINTS OF EXPLORATION. VARIATIONS IN SUBSURFACE CONDITIONS SHOULD BE EXPECTED BETWEEN
- 11. UPON COMPLETION OF NEW COLUMN INSTALLATION AND TRANSFERENCE OF LOAD, TEMPORARY SUPPORT CAISSON WILL BE REMOVED (REFERENCE URBAN FOUNDATION SUPPORT DRAWINGS FOR DETAIL).
- 12. REFER TO DEMOLITION BRACING PLANS BY HOWARD SHAPIRO.

Roxane Tsirigotis, RA R. Tainizatio NYC Development Hub

PHASE-3: EXCAVATION AND BRACING OF CAISSONS WHILE EXCAVATION

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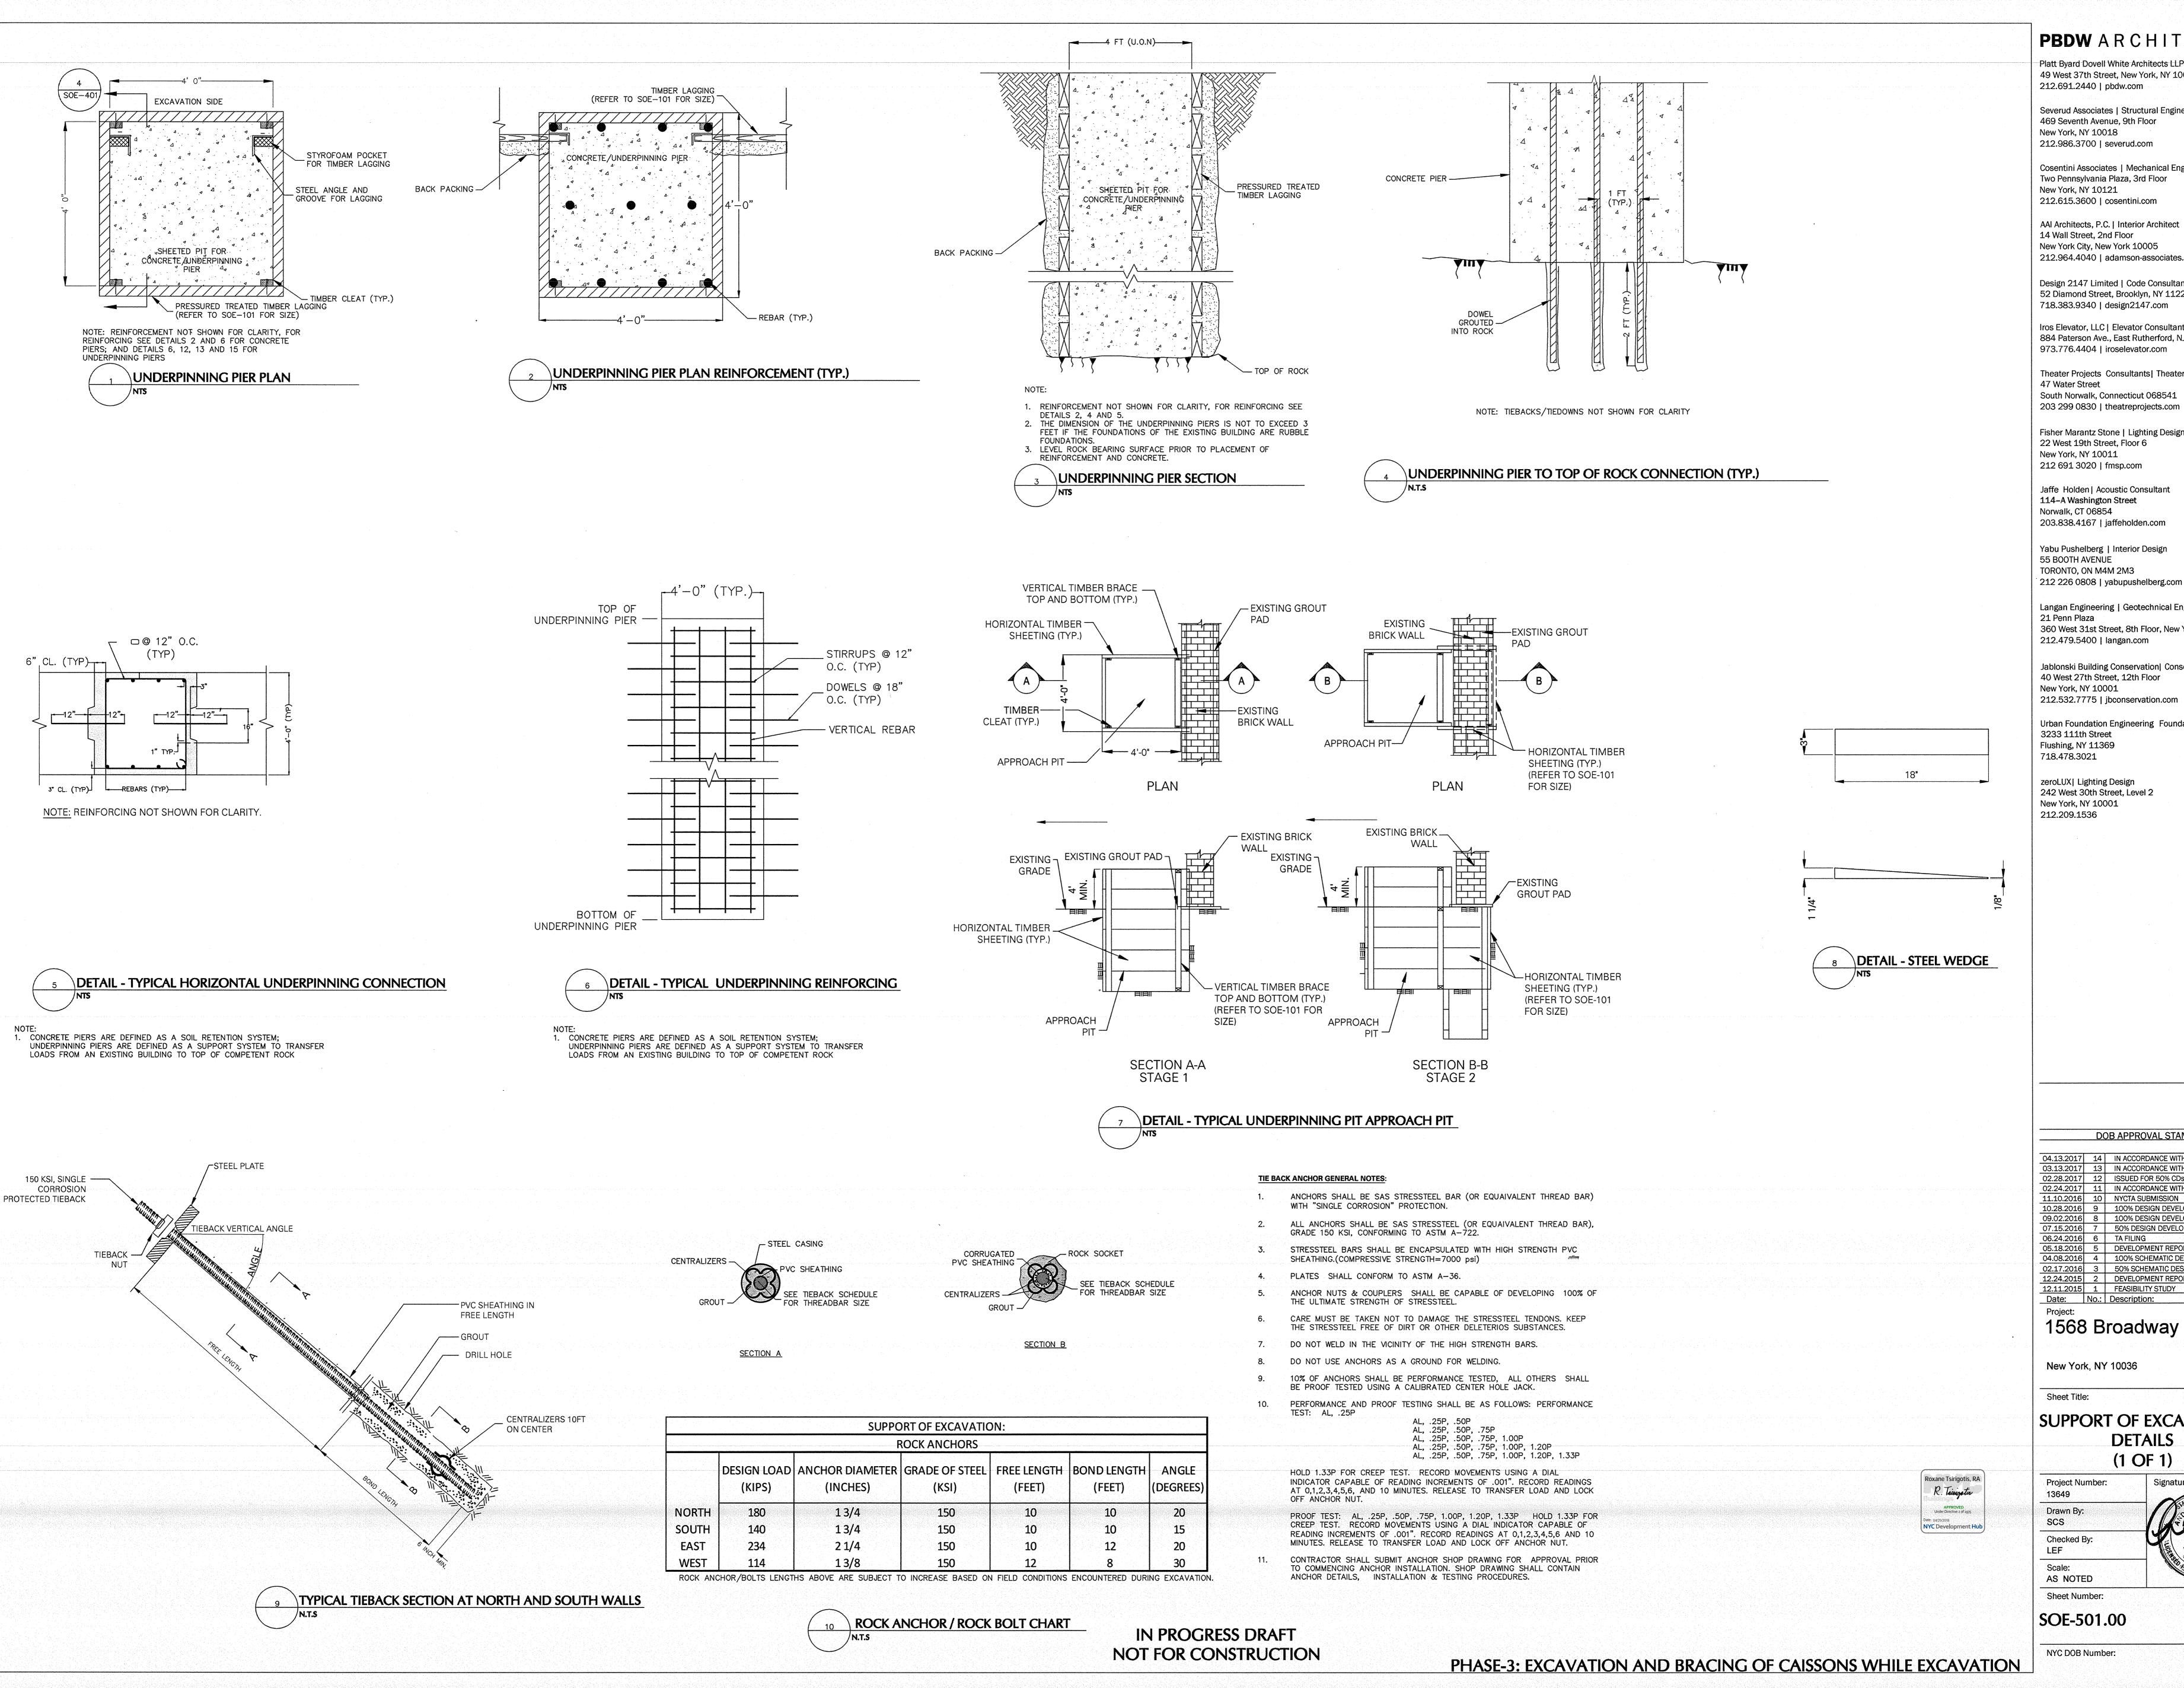
SUPPORT OF EXCAVATION TRANSIT AUTHORITY SECTION (4 OF 4)

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SUPPORT OF EXCAVATION **DETAILS** (1 OF 1)

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Checked By:

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